Equipment Manufacturer



350-1724



Equipment Manufacturer



350-1724





PLAYWORLD SYSTEMS, INC.

1000 Buffalo Road Lewisburg, PA 17837-9795 USA

**EQUIPMENT SIZE:** 

23'4" x 18'6" x 13'2"

7,11M x 5,64M x 4,01M

USE ZONE: **35'8" x 30'8"** 

10,88M x 9,35M

AREA: **865 SqFt.** 

PERIMETER:

S

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CATALOG PRE-DESIGN

80,36 SqM.

**114 Ft.** 33,53M

FALL HEIGHT:

**4 Ft.** 1,22M

USER CAPACITY: 48

AGE GROUP: **2-5** 

		JLE	Total Elevated Play Activities: 7					
		EDL	Total Ground	d-Level Play Activ	vities: 2			
		ADA SCHEDULE	Accessible Elevated Activities	Accessible Ground-Level Activities	Accessible Ground-Level Play Types			
	Required		3	3 2				
Provide		ided	7	2	2			

✓ ASTM F1487-17


✓ CPSC #325



PROJECT NO:	SCALE:
350-1724A	1/4"=1'-0"
DRAWN BY:	Paper Size
M. MERTZ	1 aper oize

DATE: **21-DEC-17** 

B

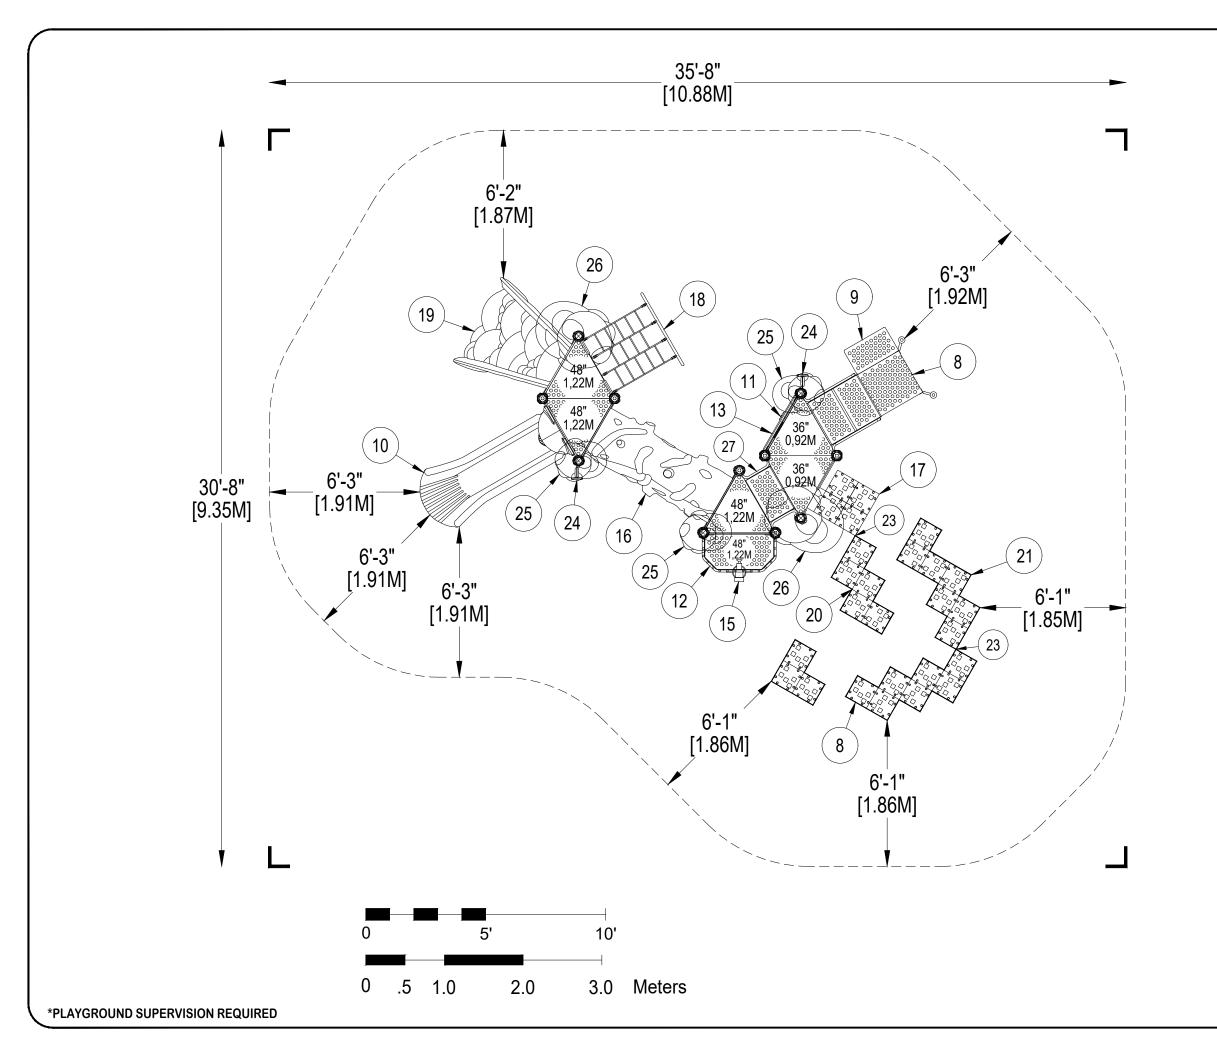



PLAYWORLD SYSTEMS, INC.

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			7	2	2		

✓ ASTM F1487-17

✓ CPSC #325




PROJECT NO: <b>350-1724A</b>	SCALE: 1/4"=1'-0"
DRAWN BY: M. MERTZ	Paper Size
DATE:	B
04 DEO 47	

DATE: 21-DEC-17


# DETAIL 1

# Support Post, Spiral Slide and RockBlocks Post Footing Detail

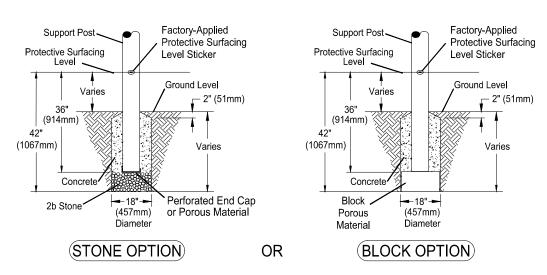

## DETAIL 2

## GroundZerO. Cantilever and "T" Post Footing Detail

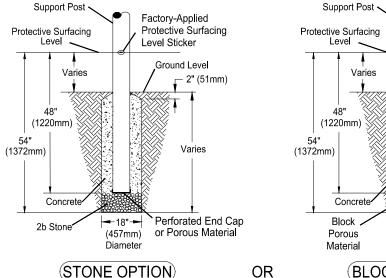


(BLOCK OPTION)

(457mm)


Diameter

# DETAIL 3 Component Footing Detail

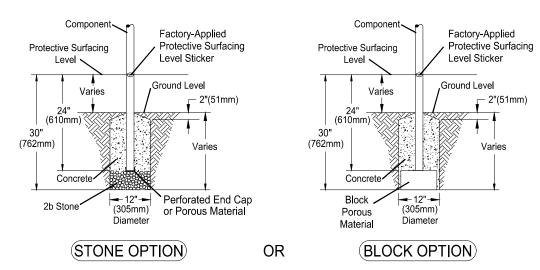

# DETAIL 4

### Surface Mount Detail

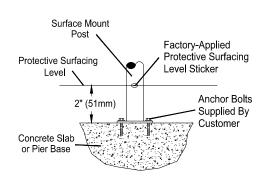

## **INSTALLATION NOTES:**

1) Paved surfaces, such as asphalt and concrete, are not acceptable for use under your structure.

Factory-Applied

Level Sticker

Protective Surfacing

Ground Level

Varies

2" (51mm)

- 2) It is the consumer's responsibility to check with local utilities prior to excavating footings for any underground utility lines that may exist within the installation area.
- 3) It is the consumer's responsibility to check local soil conditions and drainage within the site area. Inquire with local contractors for appropriate recommendations.
- 4) If the structure is to be installed across uneven terrain maintain the support post mark for protective surfacing level at the lowest grade. Adjust other footings accordingly.
- 5) The base of footings must be below frost lines.
- 6) Do not encase the bottom of support posts in concrete. Place all posts directly on packed stone.
- 7) Assemble the entire structure before pouring concrete unless specifically instructed to do so in the individual component installation instructions.
- 8) Read completely the installation instructions provided with your structure prior to beginning construction.

#### SITE NOTES:

- 1) The site plan provided must be checked against the actual site area to ensure that placement of your structure meets required clearances.
- 2) The dimensions labeled are for location of footing holes, not exact placement of equipment. Assemble, plumb, and level equipment before pouring concrete.
- 3) There must be a minimum distance of 6' (1830mm) between any obstacle, sidewalk, etc., and your structure.
- 4) Slides must have a use zone that extends out from the lower exit section of the slide a distance that is at least 6' (1830mm) or equal to the vertical distance from the highest point of the sliding surface to the top of the protective surfacing, whichever is greater. The slide use zone should not extend greater than 8' (2438mm) from the end of the lower exit section
- 5) The complete area, including the space under and around the equipment, must be covered with an impact attenuating material. See the 1997 publication, "Handbook for Public Playground Safety" published by the U.S. Consumer Product Safety Commission, for guidelines and recommendations on the type and depth of surfacing material. For a copy of the "Handbook for Public Playground Safety" write to: U.S. Consumer Product Safety Commission Office of Information and Public Affairs

Washington, D.C. 20207


6) Supervise children as they play

# ⇒ PLAYWORLD\*

PLAYWORLD SYSTEMS, INC.

1000 Buffalo Road Lewisburg, PA 17837-9795 USA

#### **FOOTING LEGEND**

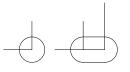

COMPONENT FOOTING (DETAIL 3)



CHALLENGERS

**PLAYMAKERS** 

F0

SPIRAL SLIDE CENTER POST FOOTING (DETAIL1)



SUPPORT POST FOOTING (DETAIL 1 or 4) (112" INDICATES POST LENGTH)



CANTILEVER, "T" POST, AND COMPONENT POST FOOTING (DETAIL 2) (ZZCH1850 INDICATES PART NUMBER)



GROUND ZERO POST FOOTING (DETAIL 2) (144" INDICATES POST LENGTH)

**FOOTING DETAIL** 

SCALE: NOT TO SCALE

DRAWN BY: **TECH SALES** 

28-JUNE-13

Paper Size

В

FOOTING LEGEND

1000 Buffalo Road Lewisburg, PA 17837-9795 USA

COMPONENT FOOTING (DETAIL 3)



SPIRAL SLIDE CENTER POST FOOTING (DETAIL1)

MI

CATALOG PRE-DESIGN



SUPPORT POST FOOTING (DETAIL 1 or 4) (112" INDICATES POST LENGTH)




CANTILEVER, "T" POST, AND COMPONENT POST FOOTING (DETAIL 2)
(ZZCH1850 INDICATES PART NUMBER)



DRAWN BY:

GROUND ZERO POST FOOTING (DETAIL 2) (144" INDICATES POST LENGTH) PROJECT NO: SCALE: 350-1724A 1/4"=1'-0" Paper Size M. MERTZ B DATE: 21-DEC-17

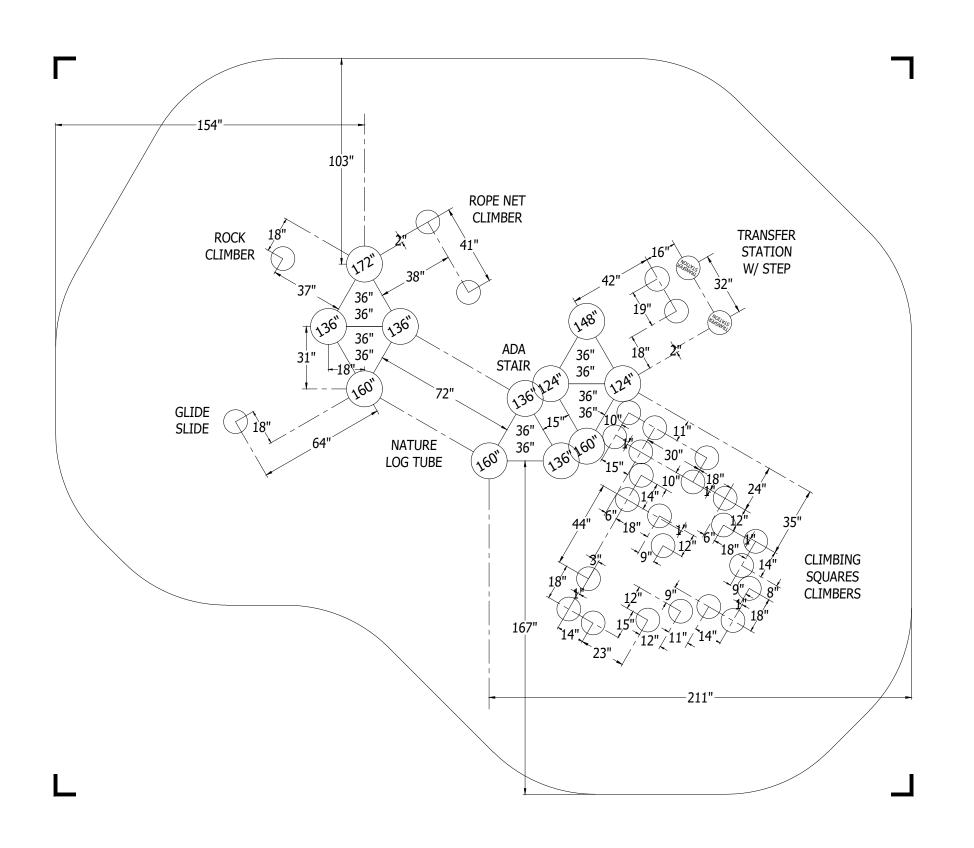

Design Number: 350-1724A - Bill Of Material

Ref.

No.	Part No.	Description	Quantity					
	Posts							
1	ZZCH0018	3.5in OD x 124in STEEL POST W/RIVETED CAP	2					
	ZZCH0028	3.5in OD x 136in STEEL POST W/ RIVETED CAP	4					
3	ZZCH0039	3.5in OD x 148in STEEL POST W/O CAP	1					
4	ZZCH0049	3.5in OD x 160in STEEL POST W/O CAP	3					
5	ZZCH0059	3.5in OD x 172in STEEL POST W/O CAP	1					
	Decks & Kick Plates							
6	ZZCH0617	TRIANGULAR COATED DECK ASSEMBLY	5					
7	ZZUN2290	COATED DECK TO DECK CONNECTION KIT	2					
	<b>ADA Items</b>							
8	ZZCH2006	TRANSFER STATION (36in DECK)	1					
9	ZZUN2019	APPROACH STEP FOR TRANSFER STATION	1					
	Slides							
10	ZZCH3126	GLIDE SLIDE (48in DECK)	1					
	<b>Activity Pan</b>	els						
11	ZZCH4328	ANIMAL LOCATOR PANEL	1					
12	ZZCH4356	BALCONY	1					
13	ZZCH4408	ACCESSIBLE BUGS PANEL	1					
14	ZZCH4549	NATURE HUNT PANEL (GROUND LEVEL)	1					
15	ZZUN4279	TELESCOPE PIPE WALL MOUNT (CH/EX)	1					
	<b>Crawl Tubes</b>	<b>3</b>						
16	ZZCH5206	NATURE LOG TUBE (DECK LEVEL)	1					
	Climbers							
17	ZZCH7087	CLIMBING SQUARES BLOCK CLIMBER (36in)	1					
18	ZZCH7227	ROPE CLIMBER (48in DECK)	1					
19	ZZCH7439	ROCK CLIMBER (48in DECK)	1					
20	ZZUN7106	CLIMBING SQUARES- CLUSTER 4	1					
21	ZZUN7107	CLIMBING SQUARES- CLUSTER 5	1					
22	ZZUN7116	CLIMBING SQUARES- CLUSTER 8	1					
23	ZZUN7118	CLIMBING SQUARES- CORNER TO CORNER BRACKET	2					
	Audible Acti	vities						
24	ZZCH4467	GROUND TO GROUND BABBLE-ON	1					
	Roofs & Arc	hes						
25	ZZCH9806	SMALL TREE TOPPER	3					
26	ZZCH9807	LARGE TREE TOPPER	2					
	Stairs and L	adders						
27	ZZCH9168	12in ACCESS STEPPED PLATFORM (DECK TO DECK)	1					
	Additional T	ool & Maintenance Kits						
28	ZZCHGUID	CHALLENGER GUIDELINES	1					
29	ZZUN9910	SURFACING WARNING LABEL KIT	1					
30	ZZUN9930	PIPE SYSTEMS MAINTENANCE KIT W/ AEROSOL	1					

Design Number: 350-1724A - Compliance and Technical Data

Reference Document: ASTM F1487

Ref. No.	Part No.	Qty.	Description	Unit ASTM Status	Total Weight (lbs)	Pre- Post- Consumer Recycled Content (lbs)	CO2e Footprint (kgs)	Users	Install Hours	Concrete (Yds3)	Active Play Events
1	ZZCH0018	2	3.5in OD x 124in STEEL POST W/RIVETED CAP	Certified	77.82		108	0	2.00	0.25	0
2	ZZCH0028	4	3.5in OD x 136in STEEL POST W/ RIVETED CAP	Certified	174.04		234	0	4.00	0.50	0
3	ZZCH0039	1	3.5in OD x 148in STEEL POST W/O CAP	Certified	46.21		59	0	1.00	0.13	0
4	ZZCH0049	3	3.5in OD x 160in STEEL POST W/O CAP	Certified	149.73		191	0	3.00	0.38	0
5	ZZCH0059	1	3.5in OD x 172in STEEL POST W/O CAP	Certified	51.61		68	0	1.00	0.13	0
6	ZZCH0617	5	TRIANGULAR COATED DECK ASSEMBLY	Certified	149.50		600	10	5.00	0.00	0
7	ZZUN2290	2	COATED DECK TO DECK CONNECTION KIT	Certified	0.58		8	0	1.00	0.00	0
8	ZZCH2006	1	TRANSFER STATION (36in DECK)	Certified	145.80		308	2	2.00	0.09	0
9	ZZUN2019	1	APPROACH STEP FOR TRANSFER STATION	Certified	35.83		72	1	1.00	0.04	0
10	ZZCH3126	1	GLIDE SLIDE (48in DECK)	Certified	119.73		492	2	2.00	0.03	1
11	ZZCH4328	1	ANIMAL LOCATOR PANEL	Certified	47.77		329	1	0.50	0.00	1
12	ZZCH4356	1	BALCONY	Certified	71.66		214	2	1.00	0.00	1
13	ZZCH4408	1	ACCESSIBLE BUGS PANEL	Certified	33.49		234	1	1.00	0.00	1
14	ZZCH4549	1	NATURE HUNT PANEL (GROUND LEVEL)	Certified	39.36		401	2	2.00	0.00	1
15	ZZUN4279	1	TELESCOPE PIPE WALL MOUNT (CH/EX)	Certified	12.23		61	1	0.50	0.00	1
16	ZZCH5206	1	NATURE LOG TUBE (DECK LEVEL)	Certified	120.95		949	3	1.00	0.00	1
17	ZZCH7087	1	CLIMBING SQUARES BLOCK CLIMBER (36in)	N/A	129.12		437	2	4.00	0.12	1
18	ZZCH7227	1	ROPE CLIMBER (48in DECK)	Certified	48.56		1,569	2	2.00	0.06	1
19	ZZCH7439	1	ROCK CLIMBER (48in DECK)	Certified	136.38		555	3	2.00	0.03	1
20	ZZUN7106	1	CLIMBING SQUARES- CLUSTER 4	Certified	91.00		348	2	4.00	0.12	1
21	ZZUN7107	1	CLIMBING SQUARES- CLUSTER 5	Certified	127.63		499	4	5.50	0.18	1
22	ZZUN7116	1	CLIMBING SQUARES- CLUSTER 8	Certified	210.14		806	6	7.00	0.24	2
23	ZZUN7118	2	CLIMBING SQUARES- CORNER TO CORNER BRACKET	N/A	1.00		10	0	0.50	0.00	0
24	ZZCH4467	1	GROUND TO GROUND BABBLE-ON	Certified	43.15		240	2	1.50	0.00	1
25	ZZCH9806	3	SMALL TREE TOPPER	Certified	42.18		276	0	1.50	0.00	0
26	ZZCH9807	2	LARGE TREE TOPPER	Certified	60.06		318	0	1.00	0.00	0

Tuesday, October 24, 2017 Page 1 of 3 Playworld.com

Design Number: 350-1724A - Compliance and Technical Data

Reference Document: ASTM F1487

Ref. No.	Part No.	Qty.	Description	Unit ASTM Status	Total Weight (lbs)	Pre- P Consume Recycled Con (lbs)		CO2e Footprint (kgs)	Users	Install Hours	Concrete (Yds3)	Active Play Events
27	ZZCH9168	1	12in ACCESS STEPPED PLATFORM (DECK TO DECK)	Certified	70.28			277	1	2.00	0.00	0
28	ZZCHGUID	1	CHALLENGER GUIDELINES	N/A	0.00			1	0	0.25	0.00	0
29	ZZUN9910	1	SURFACING WARNING LABEL KIT	Certified	0.05			1	0	0.25	0.00	0
30	ZZUN9930	1	PIPE SYSTEMS MAINTENANCE KIT W/ AEROSOL	N/A				90				
				Totals:	2,235.86	285	508	9,749	47	59.50	2.28	15
					1,006.14 Kg	128 Kg	229 K	q 10	Metric To	ons	1.73	m3

Tuesday, October 24, 2017 Page 2 of 3 Playworld.com

Design Number: 350-1724A - Compliance and Technical Data

Reference Document: ASTM F1487

				Pre- Post-					
		Unit	Total	Consumer	CO2e				Active
Ref.		ASTM	Weight	Recycled Content	Footprint		Install	Concrete	Play
No. Part No.	Qty. Description	Status	(lbs)	(lbs)	(kgs)	Users	Hours	(Yds3)	<b>Events</b>



#### **ASTM F1487**

The lay-out for this custom playscape, design number 350-1724A, has been configured to meet the requirements of the ASTM F1487 standard. In addition, each of the above components listed as "Certified" have been tested and are IPEMA certified. Components listed as "Not Applicable" do not fall within the scope of the ASTM F1487 standard and have not been tested. IPEMA certification can be verified on the IPEMA website, www.ipema.org. In the interest of playground safety, IPEMA provides a Third Party Certification Service which validates compliance.

# 2010 ADA Standards for Accessible Design

The lay-out was also designed to meet the 2010 Standards published 15-Sep-2010, by the Department of Justice when installed over a properly maintained surfacing material that is in compliance with ASTM F1951 "Accessibility of Surface Systems Under and Around Playground Equipment" as well as ASTM F1292, "Impact Attenuation of Surfacing Materials Within the Use Zone of Playground Equipment", appropriate for the fall height of the structure.

### Installation Times

Installation times are based on one experienced installer. A crew of three experienced individuals can perform the installation within the given time, each member working 1/3 of the given hours. [Eg. Installation Time = 30 hours. For a crew of three, each member will work 10 hours on the installation for a total of 30 hours on the project.]

# Carbon Footprint

The CO2e (carbon footprint given in Kilograms and Metric Tons) listed above is a measure of the environmental impact this play structure represents from harvesting raw materials to the time it leaves our shipping dock. Playworld Systems nurtures a total corporate culture that is focused on eliminating carbon producing processes and products, reducing our use of precious raw materials, reusing materials whenever possible and recycling materials at every opportunity. Playworld Systems elected to adopt the Publicly Available Specification; PAS 2050 as published by the British Standards Institute and sponsored by Defra and the Carbon Trust. The PAS 2050 has gained international acceptance as a specification that measures the greenhouse gas emissions in services and goods throughout their entire life cycle.

### Pre-Consumer Recycle Content

A measurement, in pounds, that qualifies the amount of material that was captured as waste and diverted from landfill during an initial manufacturing process and is being redirected to a separate manufacturing process to become a different product. E.g. 100% of our Aluminum Tubing is made from captured waste material during the manufacturing process of extruded Aluminum products such as rods, flat bars and H-channels.

### Post-Consumer Recycle Content

A measurement, in pounds, that qualifies the amount of material that was once another product that has completed its lifecycle and has been diverted from a landfill as a solid waste through recycling and is now being used in a Playworld Systems' product. E.g. \*\*20% to 40% of the steel in our steel tubing and sheet steel have been diverted from landfills. Automobiles are scrapped and recyclable steel is purchased by the steel mill that produces our raw product. \*\* The amount of Post-Consumer recycled steel fluctuates daily based on the availability of the recycled steel.

