
350-1824

Equipment Manufacturer

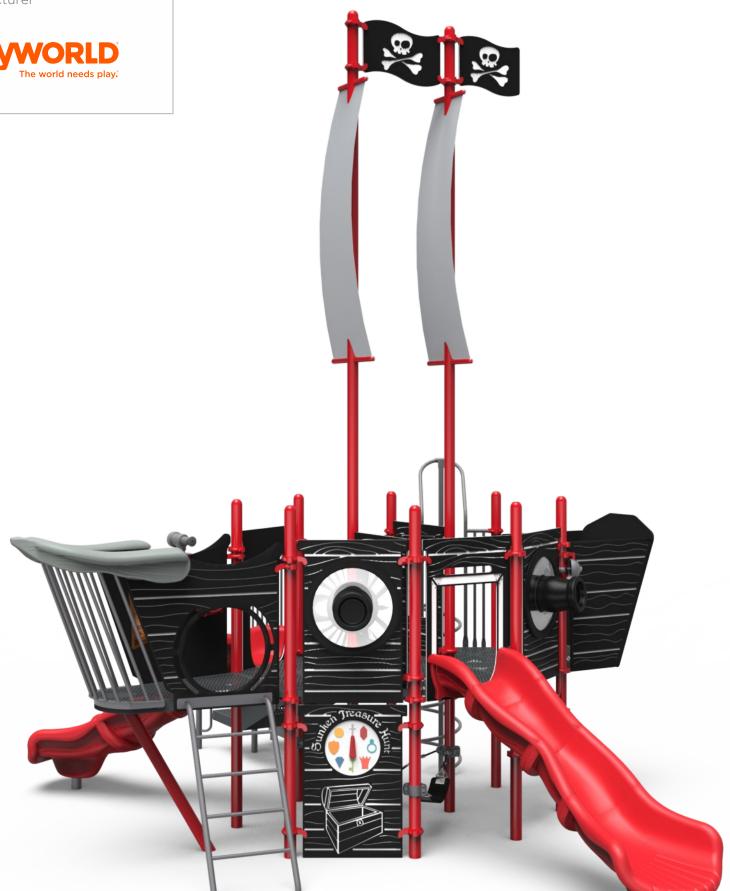


350-1824

Equipment Manufacturer







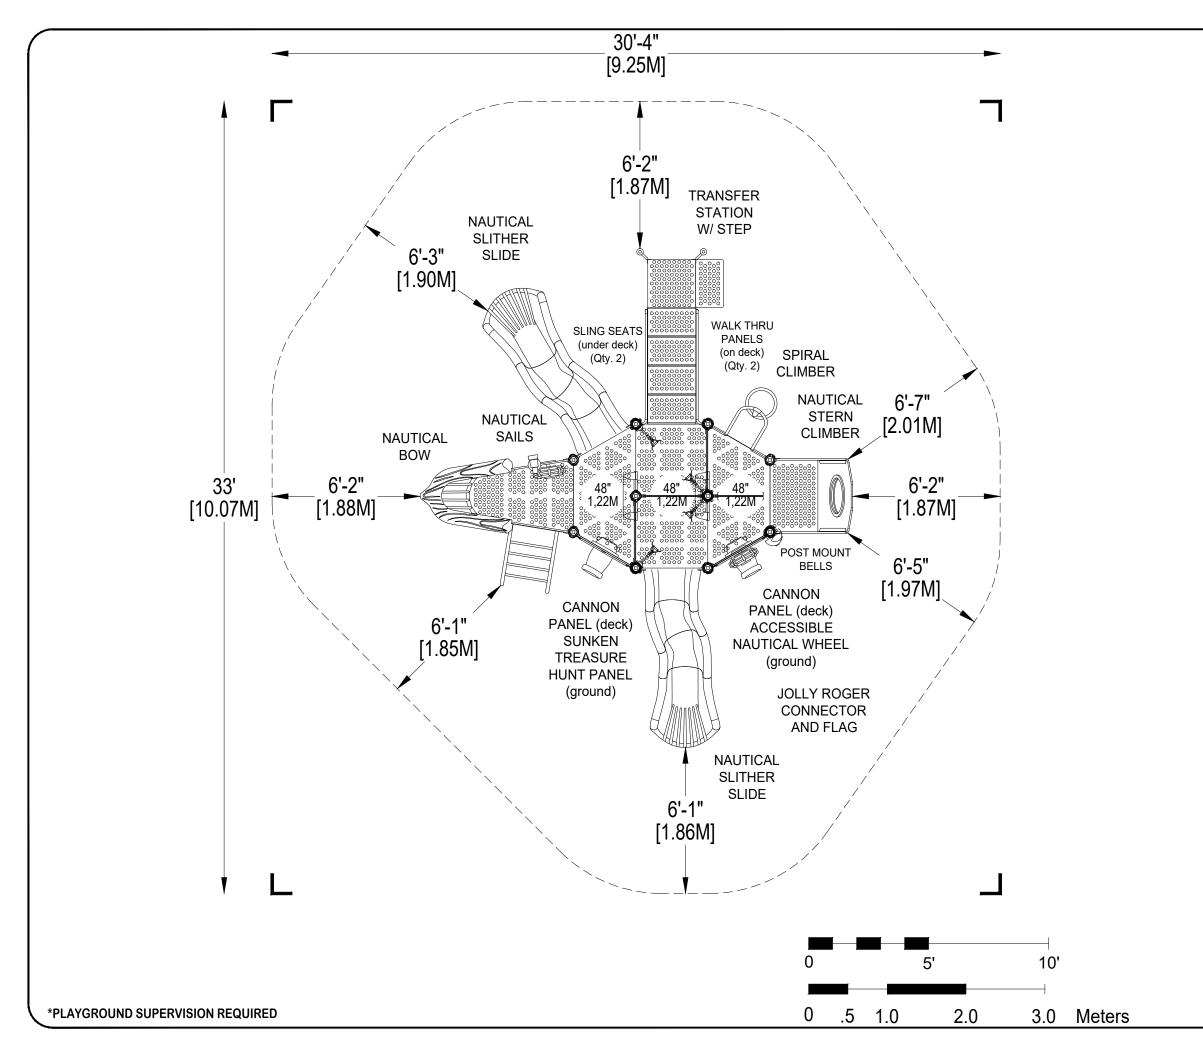

> PLAYWORLD

PLAYWORLD SYSTEMS, INC.

1000 Buffalo Road Lewisburg, PA 17837-9795 USA

EQUIPMENT SIZE:

18' x 20'9" x 21'1"

5,49M x 6,32M x 6,43M

USE ZONE: **30'4" x 33'**

9,25M x 10,07M

AREA: **747 SqFt.**

PERIMETER: **99 Ft.**

69,4 SqM.

30,18M

FALL HEIGHT: **4 Ft.**

1,22M

USER CAPACITY:

AGE GROUP:

47

2-5

		JLE	Total Elevated Play Activities: 12					
		EDL	Total Ground-Level Play Activities: 6					
		ADA SCHEDULE	Accessible Elevated Activities	Accessible Ground-Level Activities	Accessible Ground-Level Play Types			
	Required Provided		6	4	3			
			12	4	3			

✓ ASTM F1487-17

✓ CPSC #325

30-OCT-17



PROJECT NO:	SCALE:
350-1824	1/4"=1'-0"
DRAWN BY:	Paper Size
M. MERTZ	T aper 6/20
DATE:	В
00 OOT 47	

> PLAYWORLD

PLAYWORLD SYSTEMS, INC.

1000 Buffalo Road Lewisburg, PA 17837-9795 USA

EQUIPMENT SIZE:

18' x 20'9" x 21'1"

5,49M x 6,32M x 6,43M

USE ZONE: **30'4" x 33'**

9,25M x 10,07M

AREA: **747 SqFt.**

PERIMETER: **99 Ft.**

69,4 SqM.

30,18M

FALL HEIGHT: **4 Ft.**

1,22M

USER CAPACITY:

AGE GROUP:

47

2-5

		J.E	Total Elevate	ed Play Activities:	: 12				
		EDL	Total Ground	Total Ground-Level Play Activities: 6					
		ADA SCHEDULE	Accessible Elevated Activities	Accessible Ground-Level Activities	Accessible Ground-Level Play Types				
	Required Provided		6	4	3				
			12	4	3				

✓ ASTM F1487-17

✓ CPSC #325

30-OCT-17




PROJECT NO:	SCALE:
350-1824	1/4"=1'-0"
DRAWN BY:	Paper Size
M. MERTZ	T aper oize
DATE:	B
20 OCT 47	

JOLLY ROGER
CATALOG PRE-DESIGN


DETAIL 1

Support Post, Spiral Slide and RockBlocks Post Footing Detail

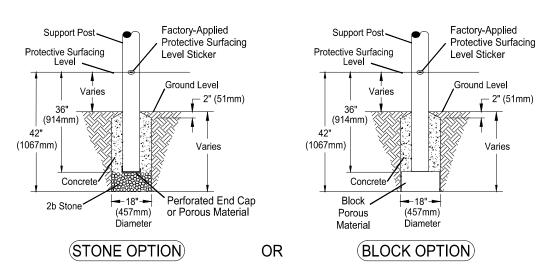

DETAIL 2

GroundZerO. Cantilever and "T" Post Footing Detail

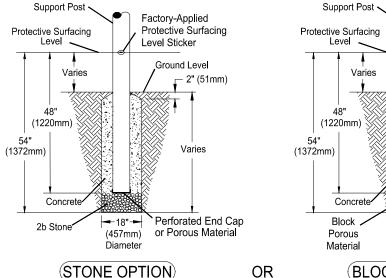


(BLOCK OPTION)

(457mm)


Diameter

DETAIL 3 Component Footing Detail

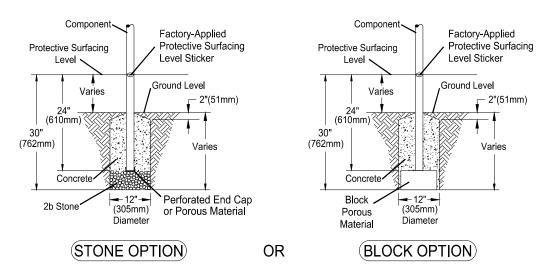

DETAIL 4

Surface Mount Detail

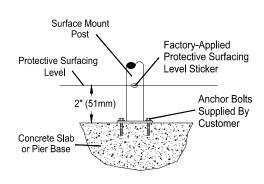

INSTALLATION NOTES:

1) Paved surfaces, such as asphalt and concrete, are not acceptable for use under your structure.

Factory-Applied

Level Sticker

Protective Surfacing

Ground Level

Varies

2" (51mm)

- 2) It is the consumer's responsibility to check with local utilities prior to excavating footings for any underground utility lines that may exist within the installation area.
- 3) It is the consumer's responsibility to check local soil conditions and drainage within the site area. Inquire with local contractors for appropriate recommendations.
- 4) If the structure is to be installed across uneven terrain maintain the support post mark for protective surfacing level at the lowest grade. Adjust other footings accordingly.
- 5) The base of footings must be below frost lines.
- 6) Do not encase the bottom of support posts in concrete. Place all posts directly on packed stone.
- 7) Assemble the entire structure before pouring concrete unless specifically instructed to do so in the individual component installation instructions.
- 8) Read completely the installation instructions provided with your structure prior to beginning construction.

SITE NOTES:

- 1) The site plan provided must be checked against the actual site area to ensure that placement of your structure meets required clearances.
- 2) The dimensions labeled are for location of footing holes, not exact placement of equipment. Assemble, plumb, and level equipment before pouring concrete.
- 3) There must be a minimum distance of 6' (1830mm) between any obstacle, sidewalk, etc., and your structure.
- 4) Slides must have a use zone that extends out from the lower exit section of the slide a distance that is at least 6' (1830mm) or equal to the vertical distance from the highest point of the sliding surface to the top of the protective surfacing, whichever is greater. The slide use zone should not extend greater than 8' (2438mm) from the end of the lower exit section
- 5) The complete area, including the space under and around the equipment, must be covered with an impact attenuating material. See the 1997 publication, "Handbook for Public Playground Safety" published by the U.S. Consumer Product Safety Commission, for guidelines and recommendations on the type and depth of surfacing material. For a copy of the "Handbook for Public Playground Safety" write to: U.S. Consumer Product Safety Commission Office of Information and Public Affairs

Washington, D.C. 20207


6) Supervise children as they play

⇒ PLAYWORLD*

PLAYWORLD SYSTEMS, INC.

1000 Buffalo Road Lewisburg, PA 17837-9795 USA

FOOTING LEGEND

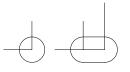

COMPONENT FOOTING (DETAIL 3)



CHALLENGERS

PLAYMAKERS

F0

SPIRAL SLIDE CENTER POST FOOTING (DETAIL1)



SUPPORT POST FOOTING (DETAIL 1 or 4) (112" INDICATES POST LENGTH)



CANTILEVER, "T" POST, AND COMPONENT POST FOOTING (DETAIL 2) (ZZCH1850 INDICATES PART NUMBER)



GROUND ZERO POST FOOTING (DETAIL 2) (144" INDICATES POST LENGTH)

FOOTING DETAIL

SCALE: NOT TO SCALE

DRAWN BY: **TECH SALES**

28-JUNE-13

Paper Size

В

FOOTING LEGEND

Lewisburg, PA

17837-9795 USA



COMPONENT FOOTING (DETAIL 3)



SPIRAL SLIDE CENTER POST FOOTING (DETAIL1)

ROGER

CATALOG PRE-DESIGN



SUPPORT POST FOOTING (DETAIL 1 or 4) (112" INDICATES POST LENGTH)



CANTILEVER, "T" POST, AND COMPONENT POST FOOTING (DETAIL 2) (ZZCH1850 INDICATES PART NUMBER)




GROUND ZERO POST FOOTING (DETAIL 2) (144" INDICATES POST LENGTH)

PROJECT NO: **350-1824**

SCALE: 1/4"=1'-0"

DRAWN BY: M. MERTZ Paper Size

DATE: 30-OCT-17

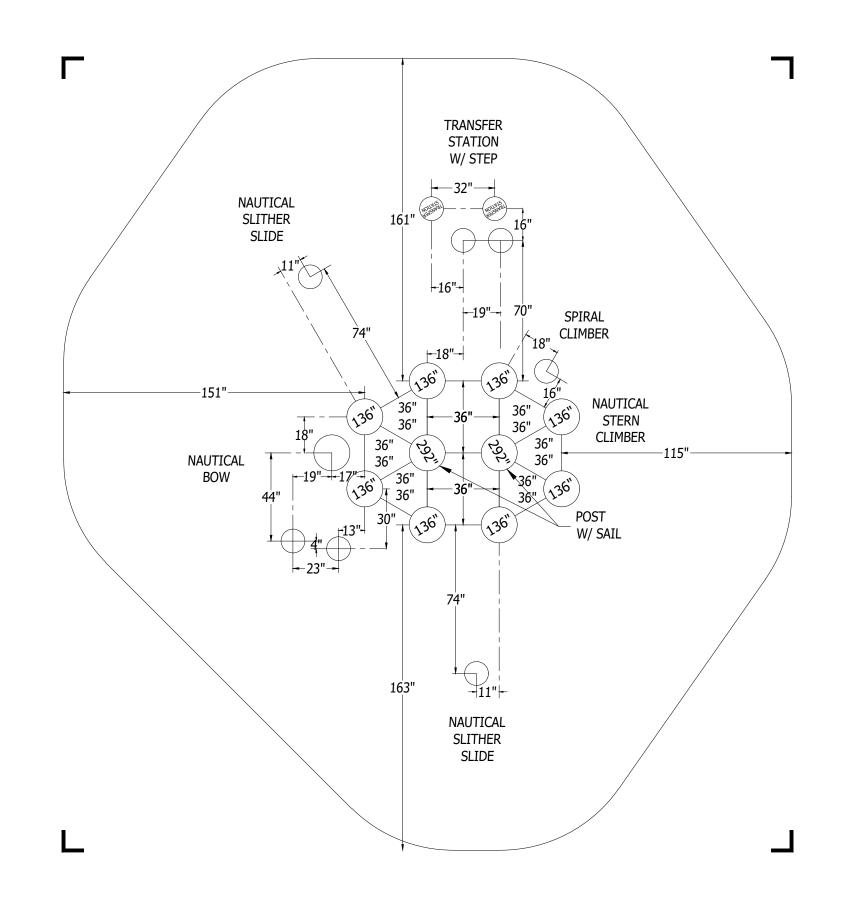

Design Number: 350-1824 - Bill Of Material

Ref.

NO.	Part No.	Description	Quantity
	Posts		
1	ZZCH0028	3.5in OD x 136in STEEL POST W/ RIVETED CAP	8
2	ZZCH8566	NAUTICAL SAIL	2
	Decks & Kick	k Plates	
3	ZZCH0618	1/2 HEX COATED DECK ASSEMBLY	2
4	ZZCH0629	LONG COATED DECK ASSEMBLY	1
5	ZZUN2290	COATED DECK TO DECK CONNECTION KIT	4
	ADA Items		
6	ZZCH2027	TRANSFER STATION (48in DECK)	1
7	ZZUN2019	APPROACH STEP FOR TRANSFER STATION	1
	Slides		
8	ZZCH8549	SLITHER SLIDE ENTRY/EXIT (NAUTICAL THEME)	2
9	ZZUN3208	SLITHER SLIDE 2.0 (RIGHT SECTION)	2
10	ZZUN3209	SLITHER SLIDE 2.0 (LEFT SECTION)	2
	Activity Pan	els	
11	ZZCH4896	SLING SEAT	2
12	ZZCH8557	CANNON PANEL (NAUTICAL THEME) (DECK LEVEL)	2
13	ZZCH8560	SUNKEN TREASURE HUNT (GROUND LEVEL) (NAUTICAL THEME)	1
14	ZZCH8569	NAUTICAL WALK-THRU PANEL	2
15	ZZCH8579	ACCESSIBLE NAUTICAL STEERING WHEEL PANEL	1
	Barriers		
16	ZZCH8598	NAUTICAL STERN BALCONY	1
	Climbers		
17	ZZCH8150	SPIRAL CLIMBER (48in DECK)	1
18	ZZCH8597	NAUTICAL BOW /W STEEL CLIMBER	1
	Audible Acti	vities	
19	ZZCH4556	7in BELL (POST MOUNT)	1
20	ZZCH4558	9in BELL (POST MOUNT)	1
	Roofs & Arc	hes	
21	ZZCH8539	NAUTICAL JOLLY ROGER FLAG	1
22	ZZCH8576	NAUTICAL JOLLY ROGER FLAG (SAIL CONNECTOR)	1
	Additional T	ool & Maintenance Kits	
23	ZZCHGUID	CHALLENGER GUIDELINES	1
24	ZZUN9910	SURFACING WARNING LABEL KIT	1
25	ZZUN9930	PIPE SYSTEMS MAINTENANCE KIT W/ AEROSOL	1

Design Number: 350-1824 - Compliance and Technical Data

Reference Document: ASTM F1487

Ref. No.	Part No.	Qty.	Description	Unit ASTM Status	Total Weight (lbs)	Pre- Post- Consumer Recycled Content (lbs)	CO2e Footprint (kgs)	Users	Install Hours	Concrete (Yds3)	Active Play Events
1	ZZCH0028	8	3.5in OD x 136in STEEL POST W/ RIVETED CAP	Certified	348.08		468	0	8.00	1.00	0
2	ZZCH8566	2	NAUTICAL SAIL	Certified	313.06		417	0	4.00	0.26	0
3	ZZCH0618	2	1/2 HEX COATED DECK ASSEMBLY	Certified	156.64		504	8	3.00	0.00	0
4	ZZCH0629	1	LONG COATED DECK ASSEMBLY	Certified	107.02		318	6	1.00	0.00	0
5	ZZUN2290	4	COATED DECK TO DECK CONNECTION KIT	Certified	1.16		15	0	2.00	0.00	0
6	ZZCH2027	1	TRANSFER STATION (48in DECK)	Certified	254.26		492	3	2.50	0.09	0
7	ZZUN2019	1	APPROACH STEP FOR TRANSFER STATION	Certified	35.83		72	1	1.00	0.04	0
8	ZZCH8549	2	SLITHER SLIDE ENTRY/EXIT (NAUTICAL THEME)	Certified	167.28		1,172	4	4.00	0.06	2
9	ZZUN3208	2	SLITHER SLIDE 2.0 (RIGHT SECTION)	Certified	39.18		267	0	0.50	0.00	0
10	ZZUN3209	2	SLITHER SLIDE 2.0 (LEFT SECTION)	Certified	39.18		267	0	0.50	0.00	0
11	ZZCH4896	2	SLING SEAT	Certified	35.20		293	2	1.00	0.00	2
12	ZZCH8557	2	CANNON PANEL (NAUTICAL THEME) (DECK LEVEL)	Certified	87.02		924	4	1.00	0.00	2
13	ZZCH8560	1	SUNKEN TREASURE HUNT (GROUND LEVEL) (NAUTICAL THEME)	Certified	44.18		413	2	2.00	0.00	1
14	ZZCH8569	2	NAUTICAL WALK-THRU PANEL	Certified	58.60		573	4	0.50	0.00	2
15	ZZCH8579	1	ACCESSIBLE NAUTICAL STEERING WHEEL PANEL	Certified	32.69		309	2	0.50	0.00	1
16	ZZCH8598	1	NAUTICAL STERN BALCONY	Certified	167.49		1,150	2	3.00	0.00	1
17	ZZCH8150	1	SPIRAL CLIMBER (48in DECK)	Certified	86.33		204	2	1.00	0.03	1
18	ZZCH8597	1	NAUTICAL BOW /W STEEL CLIMBER	Certified	319.96		1,573	5	10.00	0.19	4
19	ZZCH4556	1	7in BELL (POST MOUNT)	Certified	4.61		41	1	0.25	0.00	1
20	ZZCH4558	1	9in BELL (POST MOUNT)	Certified	6.21		45	1	0.25	0.00	1
21	ZZCH8539	1	NAUTICAL JOLLY ROGER FLAG	Certified	12.34		110	0	0.25	0.00	0
22	ZZCH8576	1	NAUTICAL JOLLY ROGER FLAG (SAIL CONNECTOR)	Certified	17.29		184	0	0.25	0.00	0
23	ZZCHGUID	1	CHALLENGER GUIDELINES	N/A	0.00		1	0	0.25	0.00	0

Design Number: 350-1824 - Compliance and Technical Data

Reference Document: ASTM F1487

Ref. No. Part No.	Qty. Description	Unit ASTM Status	Total Weight (lbs)	Pre- I Consumo Recycled Co (lbs)		CO2e Footprint (kgs)	Users	Install Hours	Concrete (Yds3)	Active Play Events
24 ZZUN9910	1 SURFACING WARNING LABEL KIT	Certified	0.05			1	0	0.25	0.00	0
25 ZZUN9930	1 PIPE SYSTEMS MAINTENANCE KIT W/ AEROSOL	N/A				90				
		Totals:	2,333.66	357	566	9,903	47	47.00	1.67	18
			1,050.15 Kg	161 Kg	255	Kg 10	Metric To	ons	1.27	m3

Design Number: 350-1824 - Compliance and Technical Data

Reference Document: ASTM F1487

				Pre- Post-					
		Unit	Total	Consumer	CO2e				Active
Ref.		ASTM	Weight	Recycled Content	Footprint		Install	Concrete	Play
No. Part No.	Qty. Description	Status	(lbs)	(lbs)	(kgs)	Users	Hours	(Yds3)	Events



ASTM F1487

The lay-out for this custom playscape, design number 350-1824, has been configured to meet the requirements of the ASTM F1487 standard. In addition, each of the above components listed as "Certified" have been tested and are IPEMA certified. Components listed as "Not Applicable" do not fall within the scope of the ASTM F1487 standard and have not been tested. IPEMA certification can be verified on the IPEMA website, www.ipema.org. In the interest of playground safety, IPEMA provides a Third Party Certification Service which validates compliance.

2010 ADA Standards for Accessible Design

The lay-out was also designed to meet the 2010 Standards published 15-Sep-2010, by the Department of Justice when installed over a properly maintained surfacing material that is in compliance with ASTM F1951 "Accessibility of Surface Systems Under and Around Playground Equipment" as well as ASTM F1292, "Impact Attenuation of Surfacing Materials Within the Use Zone of Playground Equipment", appropriate for the fall height of the structure.

Installation Times

Installation times are based on one experienced installer. A crew of three experienced individuals can perform the installation within the given time, each member working 1/3 of the given hours. [Eg. Installation Time = 30 hours. For a crew of three, each member will work 10 hours on the installation for a total of 30 hours on the project.]

Carbon Footprint

The CO2e (carbon footprint given in Kilograms and Metric Tons) listed above is a measure of the environmental impact this play structure represents from harvesting raw materials to the time it leaves our shipping dock. Playworld Systems nurtures a total corporate culture that is focused on eliminating carbon producing processes and products, reducing our use of precious raw materials, reusing materials whenever possible and recycling materials at every opportunity. Playworld Systems elected to adopt the Publicly Available Specification; PAS 2050 as published by the British Standards Institute and sponsored by Defra and the Carbon Trust. The PAS 2050 has gained international acceptance as a specification that measures the greenhouse gas emissions in services and goods throughout their entire life cycle.

Pre-Consumer Recycle Content

A measurement, in pounds, that qualifies the amount of material that was captured as waste and diverted from landfill during an initial manufacturing process and is being redirected to a separate manufacturing process to become a different product. E.g. 100% of our Aluminum Tubing is made from captured waste material during the manufacturing process of extruded Aluminum products such as rods, flat bars and H-channels.

Post-Consumer Recycle Content

A measurement, in pounds, that qualifies the amount of material that was once another product that has completed its lifecycle and has been diverted from a landfill as a solid waste through recycling and is now being used in a Playworld Systems' product. E.g. **20% to 40% of the steel in our steel tubing and sheet steel have been diverted from landfills. Automobiles are scrapped and recyclable steel is purchased by the steel mill that produces our raw product. ** The amount of Post-Consumer recycled steel fluctuates daily based on the availability of the recycled steel.

