Equipment Manufacturer



350-1607




350-1607

Equipment Manufacturer





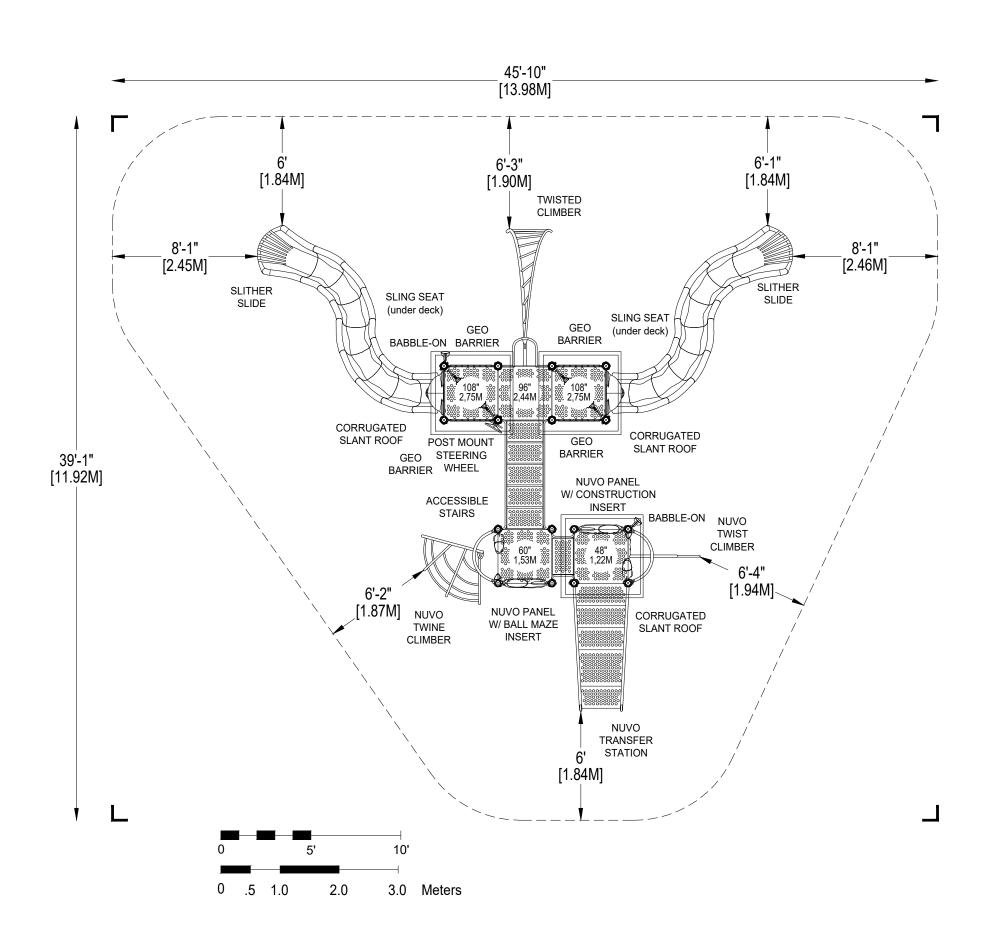

# > PLAYWORLD

PLAYWORLD SYSTEMS, INC.

1000 Buffalo Road Lewisburg, PA 17837-9795 USA

**EQUIPMENT SIZE:** 

29'-9" x 27'-0" x 18'-10"

9,07M x 8,23M x 5,74M

USE ZONE: 45'-10" x 39'-1"

13,98M x 11,92M

AREA: **1319 SqFt.** 

PERIMETER: 140 Ft.

122,54SqM.

42,67M

FALL HEIGHT:

9 Ft.

2,74M

USER CAPACITY: AGE GROUP:

36

5-12

	J.E	Total Elevated Play Activities: 7						
	ED	Total Ground	d-Level Play Activ	vities: 4				
	ADA SCHEDULE	Accessible Elevated Activities	Accessible Ground-Level Activities	Accessible Ground-Level Play Types				
Required		4	4 2					
Provi	ded	5	2	2				


✓ ASTM F1487-11

✓ CPSC #325



PROJECT NO: <b>350-1607B</b>	SCALE: 3/16"=1'-0"
DRAWN BY: M. MERTZ	Paper Size
DATE: <b>13-FEB-18</b>	B

\*PLAYGROUND SUPERVISION REQUIRED

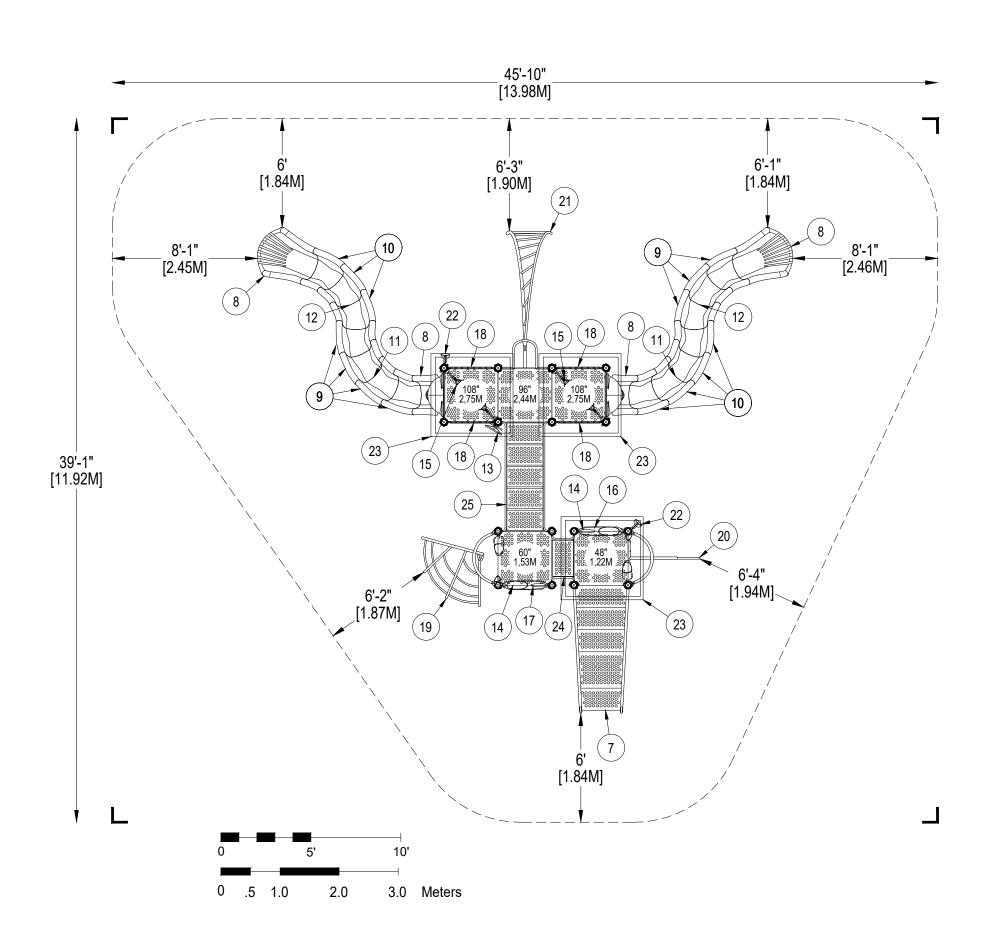

# ⇒ PLAYWORLD°

PLAYWORLD SYSTEMS, INC.

1000 Buffalo Road Lewisburg, PA 17837-9795 USA

EQUIPMENT SIZE:

29'-9" x 27'-0" x 18'-10"

9,07M x 8,23M x 5,74M

USE ZONE: 45'-10" x 39'-1"

13,98M x 11,92M

AREA: **1319 SqFt.** 

PERIMETER: 140 Ft.

122,54SqM.

42,67M

FALL HEIGHT:

9 Ft.

2,74M

AGE GROUP:

USER CAPACITY: **36** 

5-12

	JLE	Total Elevate	: 7					
	EDC	Total Ground	Total Ground-Level Play Activities: 4					
	ADA SCHEDULE	Accessible Elevated Activities	Accessible Ground-Level Activities	Accessible Ground-Level Play Types				
Required		4	4 2 2					
Provi	ded	5	2	2				

✓ ASTM F1487-11

✓ CPSC #325




PROJECT NO: 350-1607B	SCALE: 3/16"=1'-0"
DRAWN BY: M. MERTZ	Paper Size
DATE: <b>13-FEB-18</b>	В

\*PLAYGROUND SUPERVISION REQUIRED


# DETAIL 1

# Support Post, Spiral Slide and RockBlocks Post Footing Detail

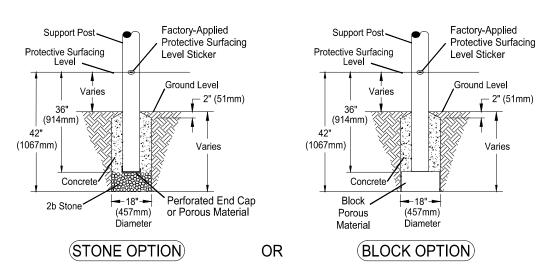

### DETAIL 2

### GroundZerO. Cantilever and "T" Post Footing Detail

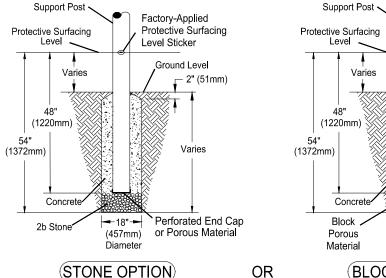


(BLOCK OPTION)

(457mm)


Diameter

# DETAIL 3 Component Footing Detail

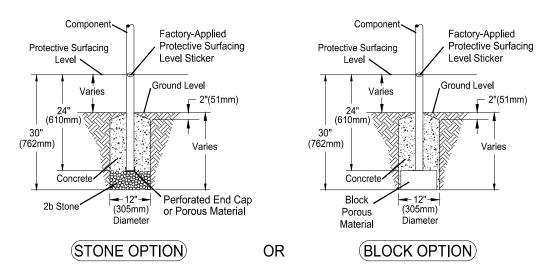

# DETAIL 4

### Surface Mount Detail

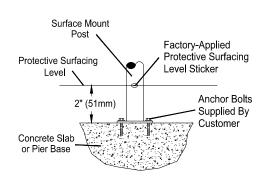

### **INSTALLATION NOTES:**

1) Paved surfaces, such as asphalt and concrete, are not acceptable for use under your structure.

Factory-Applied

Level Sticker

Protective Surfacing

Ground Level

Varies

2" (51mm)

- 2) It is the consumer's responsibility to check with local utilities prior to excavating footings for any underground utility lines that may exist within the installation area.
- 3) It is the consumer's responsibility to check local soil conditions and drainage within the site area. Inquire with local contractors for appropriate recommendations.
- 4) If the structure is to be installed across uneven terrain maintain the support post mark for protective surfacing level at the lowest grade. Adjust other footings accordingly.
- 5) The base of footings must be below frost lines.
- 6) Do not encase the bottom of support posts in concrete. Place all posts directly on packed stone.
- 7) Assemble the entire structure before pouring concrete unless specifically instructed to do so in the individual component installation instructions.
- 8) Read completely the installation instructions provided with your structure prior to beginning construction.

#### SITE NOTES:

- 1) The site plan provided must be checked against the actual site area to ensure that placement of your structure meets required clearances.
- 2) The dimensions labeled are for location of footing holes, not exact placement of equipment. Assemble, plumb, and level equipment before pouring concrete.
- 3) There must be a minimum distance of 6' (1830mm) between any obstacle, sidewalk, etc., and your structure.
- 4) Slides must have a use zone that extends out from the lower exit section of the slide a distance that is at least 6' (1830mm) or equal to the vertical distance from the highest point of the sliding surface to the top of the protective surfacing, whichever is greater. The slide use zone should not extend greater than 8' (2438mm) from the end of the lower exit section
- 5) The complete area, including the space under and around the equipment, must be covered with an impact attenuating material. See the 1997 publication, "Handbook for Public Playground Safety" published by the U.S. Consumer Product Safety Commission, for guidelines and recommendations on the type and depth of surfacing material. For a copy of the "Handbook for Public Playground Safety" write to: U.S. Consumer Product Safety Commission Office of Information and Public Affairs

Washington, D.C. 20207


6) Supervise children as they play

# ⇒ PLAYWORLD\*

PLAYWORLD SYSTEMS, INC.

1000 Buffalo Road Lewisburg, PA 17837-9795 USA

#### **FOOTING LEGEND**

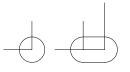

COMPONENT FOOTING (DETAIL 3)



CHALLENGERS

**PLAYMAKERS** 

F0

SPIRAL SLIDE CENTER POST FOOTING (DETAIL1)



SUPPORT POST FOOTING (DETAIL 1 or 4) (112" INDICATES POST LENGTH)



CANTILEVER, "T" POST, AND COMPONENT POST FOOTING (DETAIL 2) (ZZCH1850 INDICATES PART NUMBER)



GROUND ZERO POST FOOTING (DETAIL 2) (144" INDICATES POST LENGTH)

**FOOTING DETAIL** 


SCALE: NOT TO SCALE

DRAWN BY: **TECH SALES** 

28-JUNE-13

Paper Size

В

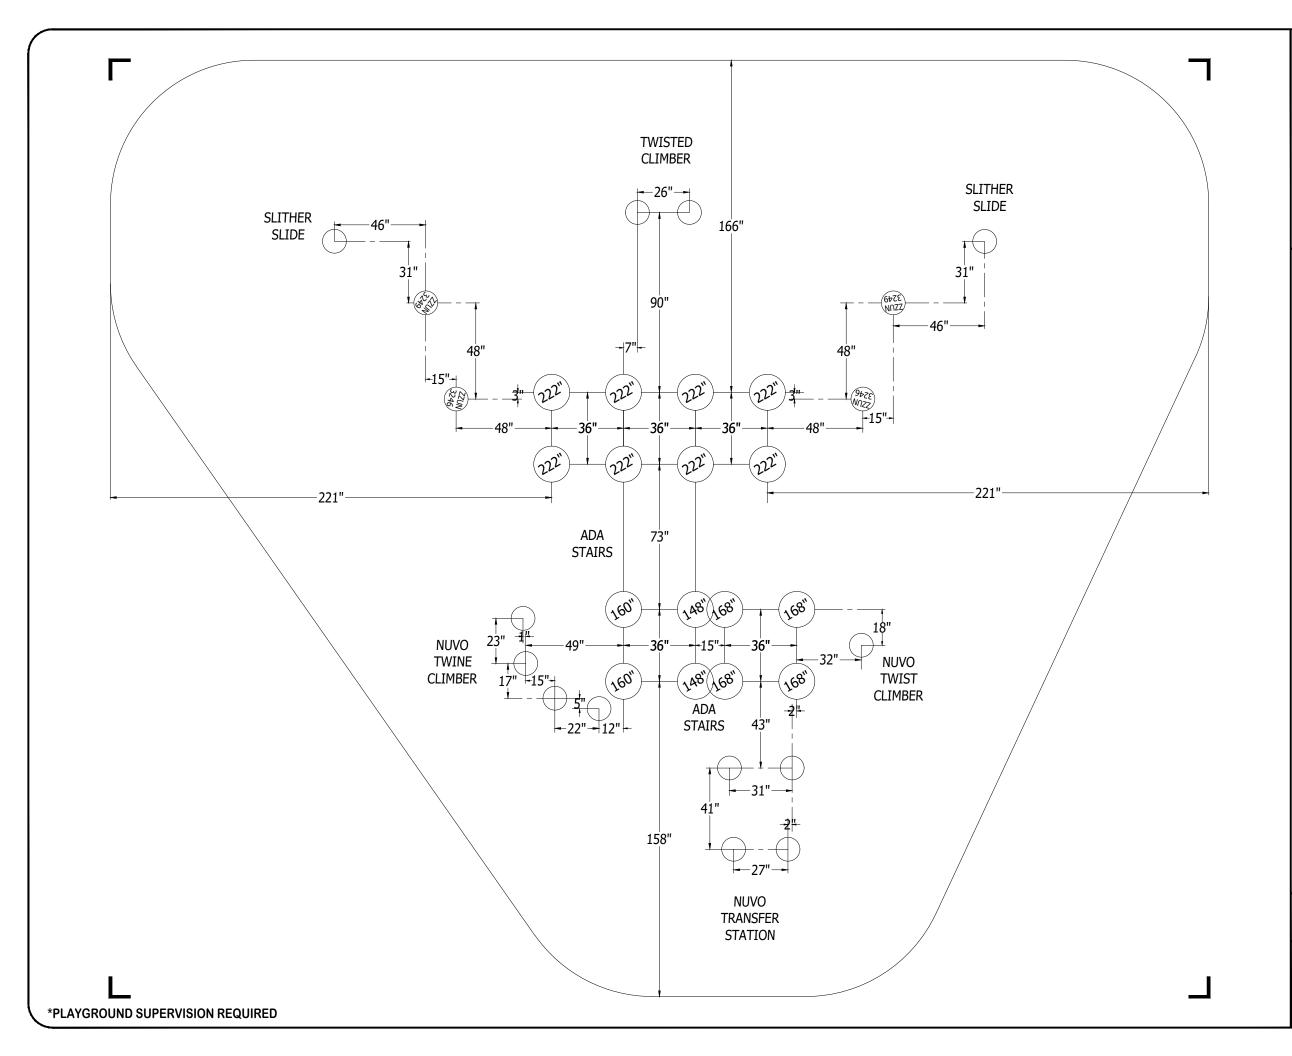

# 

PLAYWORLD SYSTEMS, INC.

1000 Buffalo Road Lewisburg, PA 17837-9795 USA

### FOOTING LEGEND



COMPONENT FOOTING (DETAIL 3)



SPIRAL SLIDE CENTER POST FOOTING (DETAIL1)



SUPPORT POST FOOTING (DETAIL 1 or 4) (112" INDICATES POST LENGTH)



CANTILEVER, "T" POST, AND COMPONENT POST FOOTING (DETAIL 2) (ZZCH1850 INDICATES PART NUMBER)



GROUND ZERO POST FOOTING (DETAIL 2) (144" INDICATES POST LENGTH)

PROJECT NO: <b>350-1607B</b>	SCALE: 1/4"=1'-0"
DRAWN BY: M. MERTZ	Paper Size
DATE:	B

13-FEB-18

Design Number: 350-1607B - Bill Of Material

Ref.

No.	Part No.	Description	Quantity
	Posts		
1	ZZCH0038	3.5in OD x 148in STEEL POST W/ RIVETED CAP	2
2	ZZCH0048	3.5in OD x 160in STEEL POST W/ RIVETED CAP	2
3	ZZCH0237	3.5in OD x 168in SWAGED STEEL POST	4
4	ZZCH0288	3.5in OD x 222in SWAGED STEEL POST	8
	Decks & Kic	k Plates	
5	ZZCH0616	SQUARE COATED DECK ASSEMBLY	5
6	ZZCH2530	12in DECK TO DECK KICK PLATE	2
	<b>ADA Items</b>		
7	ZZCH0678	NUVO- 48in TRANSFER STATION	1
	Slides		
8	ZZCH3206	SLITHER SLIDE 2.0 ENTRANCE & EXIT	2
9	ZZUN3208	SLITHER SLIDE 2.0 (RIGHT SECTION)	7
10	ZZUN3209	SLITHER SLIDE 2.0 (LEFT SECTION)	7
11	ZZUN3246	SLITHER SLIDE 2.0 SUPPORT LEG 6ft-6in	2
12	ZZUN3249	SLITHER SLIDE 2.0 SUPPORT LEG 3ft-6in	2
	<b>Activity Pan</b>	nels	
13	ZZCH4290	POST MOUNTED STEERING WHEEL	1
14	ZZCH4836	NUVO ACTIVITY PANEL	2
15	ZZCH4896	SLING SEAT	2
16	ZZUN4857	NUVO - CONSTRUCTION PANEL INSERT	1
17	ZZUN4869	NUVO - BALL MAZE PANEL INSERT	1
	Barriers		
18	ZZCH4496	GEO BARRIER	4
	Climbers		
19	ZZCH7038	60in TWINE CLIMBER	1
20	ZZCH7047	48in TWIST CLIMBER	1
21	ZZCH7167	8ft TWISTED CLIMBER	1
	<b>Audible Acti</b>	ivities	
22	ZZCH4467	GROUND TO GROUND BABBLE-ON	1
	Roofs & Arc	thes	
23	ZZCH9628	SLANT CORRUGATED ROOF	3
	Stairs and L	adders	
24	ZZCH9168	12in ACCESS STEPPED PLATFORM (DECK TO DECK)	1
25	ZZCH9177	36in ACCESS STEPPED PLATFORM (DECK TO DECK)	1
	<b>Additional T</b>	Tool & Maintenance Kits	
26	ZZCHGUID	CHALLENGER GUIDELINES	1
27	ZZUN9910	SURFACING WARNING LABEL KIT	1
28	ZZUN9930	PIPE SYSTEMS MAINTENANCE KIT W/ AEROSOL	1

Design Number: 350-1607B - Compliance and Technical Data

Reference Document: ASTM F1487

Ref. No.	Part No.	Qty.	Description	Unit ASTM Status	Total Weight (lbs)	Pre- Post- Consumer Recycled Content (lbs)	CO2e Footprint (kgs)	Users	Install Hours	Concrete (Yds3)	Active Play Events
1	ZZCH0038	2	3.5in OD x 148in STEEL POST W/ RIVETED CAP	Certified	94.22		127	0	2.00	0.25	0
2	ZZCH0048	2	3.5in OD x 160in STEEL POST W/ RIVETED CAP	Certified	100.42		136	0	2.00	0.25	0
3	ZZCH0237	4	3.5in OD x 168in SWAGED STEEL POST	Certified	206.44		273	0	2.00	0.50	0
4	ZZCH0288	8	3.5in OD x 222in SWAGED STEEL POST	Certified	560.6 <del>4</del>		711	0	8.00	1.04	0
5	ZZCH0616	5	SQUARE COATED DECK ASSEMBLY	Certified	274.30		869	15	5.00	0.00	0
6	ZZCH2530	2	12in DECK TO DECK KICK PLATE	Certified	17.70		33	0	1.00	0.00	0
7	ZZCH0678	1	NUVO- 48in TRANSFER STATION	Certified	299.54		563	3	3.50	0.12	0
8	ZZCH3206	2	SLITHER SLIDE 2.0 ENTRANCE & EXIT	Certified	170.74		848	4	4.00	0.06	2
9	ZZUN3208	7	SLITHER SLIDE 2.0 (RIGHT SECTION)	Certified	137.13		935	0	1.75	0.00	0
10	ZZUN3209	7	SLITHER SLIDE 2.0 (LEFT SECTION)	Certified	137.13		935	0	1.75	0.00	0
11	ZZUN3246	2	SLITHER SLIDE 2.0 SUPPORT LEG 6ft-6in	Certified	43.22		148	0	0.50	0.06	0
12	ZZUN3249	2	SLITHER SLIDE 2.0 SUPPORT LEG 3ft-6in	Certified	30.02		125	0	0.50	0.06	0
13	ZZCH4290	1	POST MOUNTED STEERING WHEEL	Certified	7.83		44	1	0.25	0.00	1
14	ZZCH4836	2	NUVO ACTIVITY PANEL	Certified	39.16		465	0	1.00	0.00	0
15	ZZCH4896	2	SLING SEAT	Certified	35.20		293	2	1.00	0.00	2
16	ZZUN4857	1	NUVO - CONSTRUCTION PANEL INSERT	Certified	30.80		401	1	0.50	0.00	1
17	ZZUN4869	1	NUVO - BALL MAZE PANEL INSERT	Certified	21.69		145	1	0.50	0.00	1
18	ZZCH4496	4	GEO BARRIER	Certified	153.32		634	0	4.00	0.00	0
19	ZZCH7038	1	60in TWINE CLIMBER	Certified	90.17		401	1	4.00	0.12	1
20	ZZCH7047	1	48in TWIST CLIMBER	Certified	96.81		598	1	1.50	0.03	1
21	ZZCH7167	1	8ft TWISTED CLIMBER	Certified	130.73		248	2	2.00	0.60	1
22	ZZCH4467	1	GROUND TO GROUND BABBLE-ON	Certified	43.15		240	2	1.50	0.00	1
23	ZZCH9628	3	SLANT CORRUGATED ROOF	Certified	701.61		1,799	0	4.50	0.00	0
24	ZZCH9168	1	12in ACCESS STEPPED PLATFORM (DECK TO DECK)	Certified	70.28		277	1	2.00	0.00	0
25	ZZCH9177	1	36in ACCESS STEPPED PLATFORM (DECK TO DECK)	Certified	217.24		550	2	1.50	0.00	0

Design Number: 350-1607B - Compliance and Technical Data

Reference Document: ASTM F1487

Ref. No. Part No.	Qty. Description	Unit ASTM Status	Total Weight (lbs)	Pre- Consun Recycled Co (lbs)	ontent	CO2e Footprint (kgs)	Users	Install Hours	Concrete (Yds3)	Active Play Events
26 ZZCHGUID	1 CHALLENGER GUIDELINES	N/A	0.00			1	0	0.25	0.00	0
27 ZZUN9910	1 SURFACING WARNING LABEL KIT	Certified	0.05			1	0	0.25	0.00	0
28 ZZUN9930	1 PIPE SYSTEMS MAINTENANCE KIT W/ AEROSOL	N/A				90				
		Totals:	3,709.54	585	1,054	11,886	36	56.75	3.09	11
			1.669.29 Ka	263 Ka	474	Ka 12	Metric T	ons	2.35	m3

Design Number: 350-1607B - Compliance and Technical Data

Reference Document: ASTM F1487

				Pre- Post-					
		Unit	Total	Consumer	CO2e				Active
Ref.		ASTM	Weight	Recycled Content	Footprint		Install	Concrete	Play
No. Part No.	Qty. Description	Status	(lbs)	(lbs)	(kgs)	Users	Hours	(Yds3)	<b>Events</b>



#### **ASTM F1487**

The lay-out for this custom playscape, design number 350-1607B, has been configured to meet the requirements of the ASTM F1487 standard. In addition, each of the above components listed as "Certified" have been tested and are IPEMA certified. Components listed as "Not Applicable" do not fall within the scope of the ASTM F1487 standard and have not been tested. IPEMA certification can be verified on the IPEMA website, www.ipema.org. In the interest of playground safety, IPEMA provides a Third Party Certification Service which validates compliance.

## 2010 ADA Standards for Accessible Design

The lay-out was also designed to meet the 2010 Standards published 15-Sep-2010, by the Department of Justice when installed over a properly maintained surfacing material that is in compliance with ASTM F1951 "Accessibility of Surface Systems Under and Around Playground Equipment" as well as ASTM F1292, "Impact Attenuation of Surfacing Materials Within the Use Zone of Playground Equipment", appropriate for the fall height of the structure.

### Installation Times

Installation times are based on one experienced installer. A crew of three experienced individuals can perform the installation within the given time, each member working 1/3 of the given hours. [Eg. Installation Time = 30 hours. For a crew of three, each member will work 10 hours on the installation for a total of 30 hours on the project.]

## Carbon Footprint

The CO2e (carbon footprint given in Kilograms and Metric Tons) listed above is a measure of the environmental impact this play structure represents from harvesting raw materials to the time it leaves our shipping dock. Playworld Systems nurtures a total corporate culture that is focused on eliminating carbon producing processes and products, reducing our use of precious raw materials, reusing materials whenever possible and recycling materials at every opportunity. Playworld Systems elected to adopt the Publicly Available Specification; PAS 2050 as published by the British Standards Institute and sponsored by Defra and the Carbon Trust. The PAS 2050 has gained international acceptance as a specification that measures the greenhouse gas emissions in services and goods throughout their entire life cycle.

### Pre-Consumer Recycle Content

A measurement, in pounds, that qualifies the amount of material that was captured as waste and diverted from landfill during an initial manufacturing process and is being redirected to a separate manufacturing process to become a different product. E.g. 100% of our Aluminum Tubing is made from captured waste material during the manufacturing process of extruded Aluminum products such as rods, flat bars and H-channels.

### Post-Consumer Recycle Content

A measurement, in pounds, that qualifies the amount of material that was once another product that has completed its lifecycle and has been diverted from a landfill as a solid waste through recycling and is now being used in a Playworld Systems' product. E.g. \*\*20% to 40% of the steel in our steel tubing and sheet steel have been diverted from landfills. Automobiles are scrapped and recyclable steel is purchased by the steel mill that produces our raw product. \*\* The amount of Post-Consumer recycled steel fluctuates daily based on the availability of the recycled steel.

