
Equipment Manufacturer



350-1700

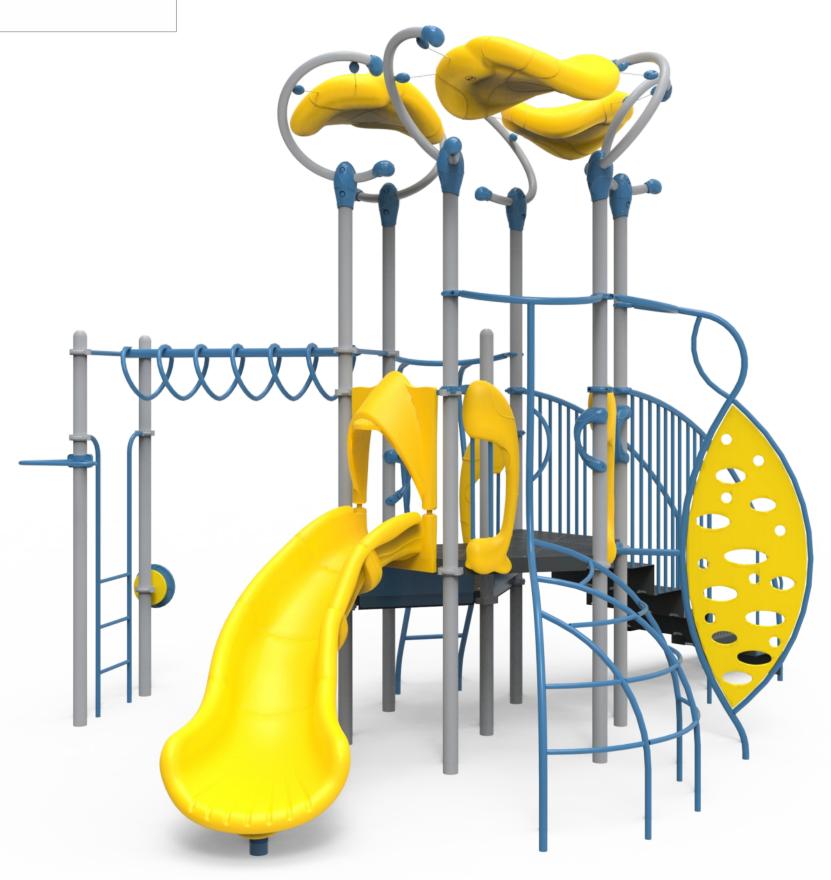


Equipment Manufacturer



350-1700



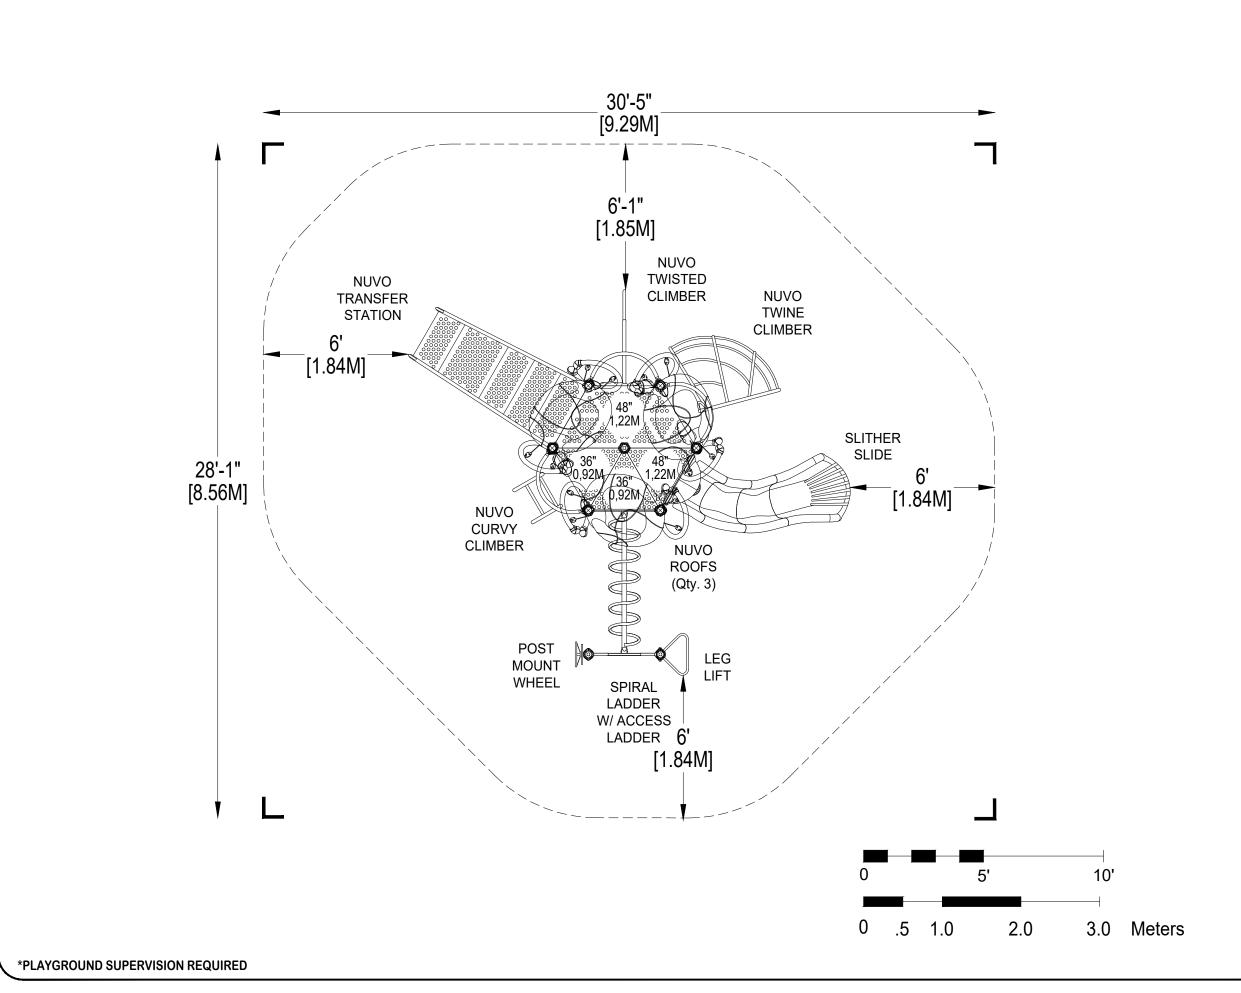

> PLAYWORLD

PLAYWORLD SYSTEMS, INC.

1000 Buffalo Road Lewisburg, PA 17837-9795 USA

EQUIPMENT SIZE:

18'4" x 16'1" x 13'10"

5,59M x 4,9M x 4,22M

USE ZONE: **30'5" x 28'1"**

9,29M x 8,56M

AREA:

PERIMETER: **94 Ft.**

666 SqFt. 61,87 SqM.

28,65M

FALL HEIGHT:

8 Ft.

2,44M

USER CAPACITY:

AGE GROUP:

23

5-12

	[E]	Total Elevate	ed Play Activities:	5			
	SCHEDULE	Total Ground-Level Play Activities: 2					
	ADA SCH	Accessible Elevated Activities	Accessible Ground-Level Activities	Accessible Ground-Level Play Types			
Req	uired	3	2	2			
Prov	/ided	3	2	2			


✓ ASTM F1487-17

✓ CPSC #325

21-DEC-17



PROJECT NO:	SCALE:
350-1700A	1/4"=1'-0"
DRAWN BY:	Paper Size
I. PERKINS	T aper oize
DATE:	В
04 DEC 47	

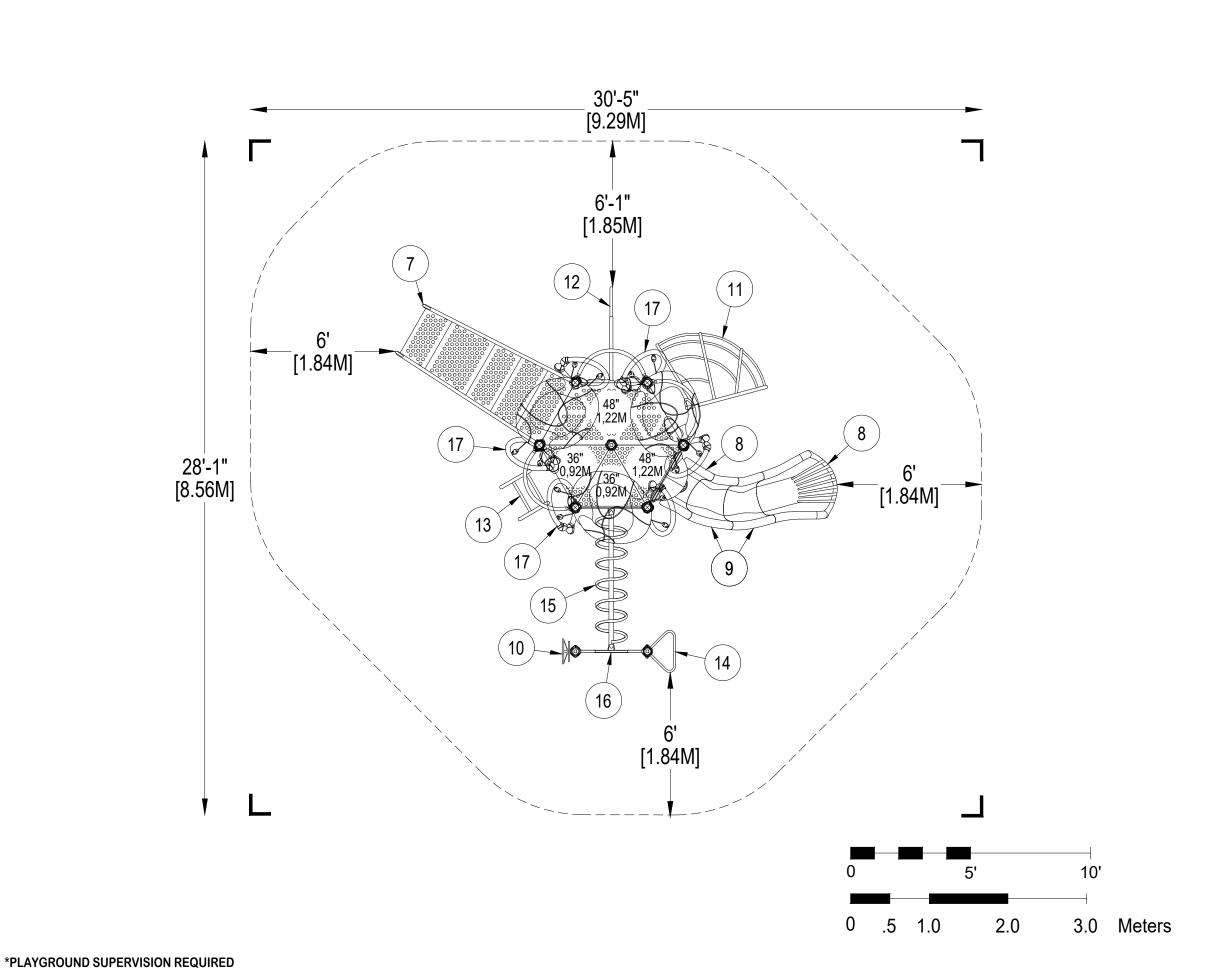

> PLAYWORLD

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✓ ASTM F1487-17

✓ CPSC #325


21-DEC-17



PROJECT NO: 350-1700A	SCALE: 1/4"=1'-0"
DRAWN BY: I. PERKINS	Paper Size
DATE:	l K


DETAIL 1

Support Post, Spiral Slide and RockBlocks Post Footing Detail

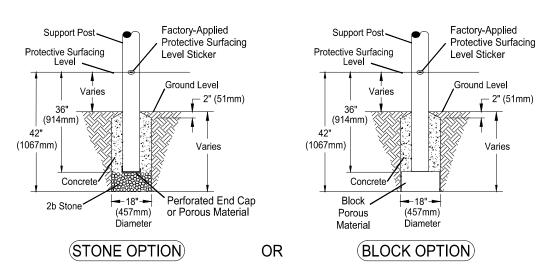

DETAIL 2

GroundZerO. Cantilever and "T" Post Footing Detail

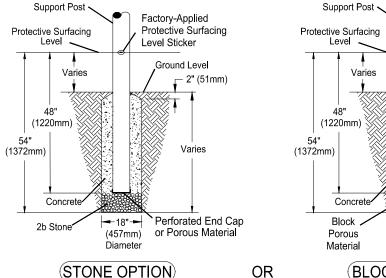


(BLOCK OPTION)

(457mm)


Diameter

DETAIL 3 Component Footing Detail

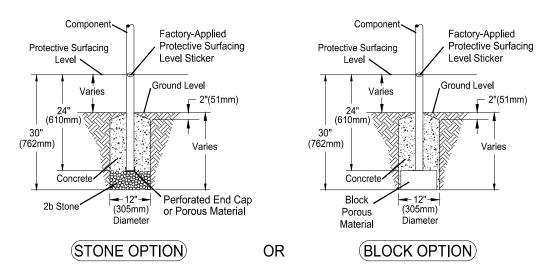

DETAIL 4

Surface Mount Detail

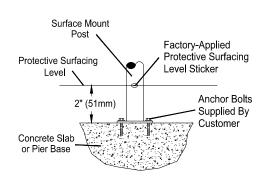

INSTALLATION NOTES:

1) Paved surfaces, such as asphalt and concrete, are not acceptable for use under your structure.

Factory-Applied

Level Sticker

Protective Surfacing

Ground Level

Varies

2" (51mm)

- 2) It is the consumer's responsibility to check with local utilities prior to excavating footings for any underground utility lines that may exist within the installation area.
- 3) It is the consumer's responsibility to check local soil conditions and drainage within the site area. Inquire with local contractors for appropriate recommendations.
- 4) If the structure is to be installed across uneven terrain maintain the support post mark for protective surfacing level at the lowest grade. Adjust other footings accordingly.
- 5) The base of footings must be below frost lines.
- 6) Do not encase the bottom of support posts in concrete. Place all posts directly on packed stone.
- 7) Assemble the entire structure before pouring concrete unless specifically instructed to do so in the individual component installation instructions.
- 8) Read completely the installation instructions provided with your structure prior to beginning construction.

SITE NOTES:

- 1) The site plan provided must be checked against the actual site area to ensure that placement of your structure meets required clearances.
- 2) The dimensions labeled are for location of footing holes, not exact placement of equipment. Assemble, plumb, and level equipment before pouring concrete.
- 3) There must be a minimum distance of 6' (1830mm) between any obstacle, sidewalk, etc., and your structure.
- 4) Slides must have a use zone that extends out from the lower exit section of the slide a distance that is at least 6' (1830mm) or equal to the vertical distance from the highest point of the sliding surface to the top of the protective surfacing, whichever is greater. The slide use zone should not extend greater than 8' (2438mm) from the end of the lower exit section
- 5) The complete area, including the space under and around the equipment, must be covered with an impact attenuating material. See the 1997 publication, "Handbook for Public Playground Safety" published by the U.S. Consumer Product Safety Commission, for guidelines and recommendations on the type and depth of surfacing material. For a copy of the "Handbook for Public Playground Safety" write to: U.S. Consumer Product Safety Commission Office of Information and Public Affairs

Washington, D.C. 20207


6) Supervise children as they play

⇒ PLAYWORLD*

PLAYWORLD SYSTEMS, INC.

1000 Buffalo Road Lewisburg, PA 17837-9795 USA

FOOTING LEGEND

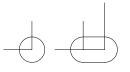

COMPONENT FOOTING (DETAIL 3)



CHALLENGERS

PLAYMAKERS

F0

SPIRAL SLIDE CENTER POST FOOTING (DETAIL1)



SUPPORT POST FOOTING (DETAIL 1 or 4) (112" INDICATES POST LENGTH)



CANTILEVER, "T" POST, AND COMPONENT POST FOOTING (DETAIL 2) (ZZCH1850 INDICATES PART NUMBER)



GROUND ZERO POST FOOTING (DETAIL 2) (144" INDICATES POST LENGTH)

FOOTING DETAIL

SCALE: NOT TO SCALE

DRAWN BY: **TECH SALES**

28-JUNE-13


Paper Size

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1000 Buffalo Road Lewisburg, PA

17837-9795 USA

FOOTING LEGEND

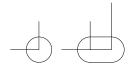

COMPONENT FOOTING (DETAIL 3)



SPIRAL SLIDE CENTER POST FOOTING (DETAIL1)



SUPPORT POST FOOTING (DETAIL 1 or 4) (112" INDICATES POST LENGTH)



CANTILEVER, "T" POST, AND COMPONENT POST FOOTING (DETAIL 2)
(ZZCH1850 INDICATES PART NUMBER)



GROUND ZERO POST FOOTING (DETAIL 2) (144" INDICATES POST LENGTH)

PROJECT NO: 350-1700A

SCALE: 1/4"=1'-0"

DRAWN BY:


Paper Size

M. MERTZ

DATE:

21-DEC-17

B

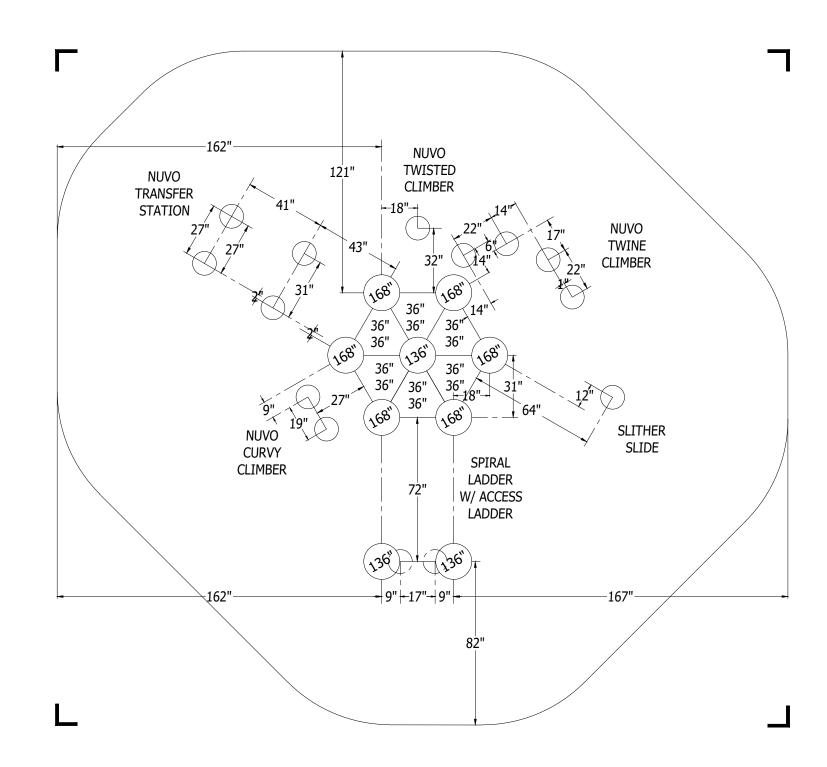

Design Number: 350-1700A - Bill Of Material

Ref.

No.	Part No.	Description	Quantity
	Posts		
1	ZZCH0028	3.5in OD x 136in STEEL POST W/ RIVETED CAP	3
2	ZZCH0237	3.5in OD x 168in SWAGED STEEL POST	6
	Decks & Kick	k Plates	
3	ZZCH0617	TRIANGULAR COATED DECK ASSEMBLY	3
4	ZZCH0618	1/2 HEX COATED DECK ASSEMBLY	1
5	ZZCH2530	12in DECK TO DECK KICK PLATE	2
6	ZZUN2290	COATED DECK TO DECK CONNECTION KIT	2
	ADA Items		
7	ZZCH0678	NUVO- 48in TRANSFER STATION	1
	Slides		
8	ZZCH3206	SLITHER SLIDE 2.0 ENTRANCE & EXIT	1
9	ZZUN3209	SLITHER SLIDE 2.0 (LEFT SECTION)	2
	Activity Pan	els	
10	ZZCH4290	POST MOUNTED STEERING WHEEL	1
	Climbers		
11	ZZCH7037	48in TWINE CLIMBER	1
12	ZZCH7047	48in TWIST CLIMBER	1
13	ZZCH7056	36in CURVY CLIMBER	1
	Overhead Ev	vents	
14	ZZCH5770	LEG LIFT	1
15	ZZCH5880	6ft HORIZONTAL SPIRAL LADDER	1
16	ZZCH5970	OVERHEAD EVENT ACCESS LADDER (36in DECK)	1
	Roofs & Arcl	hes	
17	ZZCH9867	NUVO ROOF	3
	Additional T	ool & Maintenance Kits	
18	ZZCHGUID	CHALLENGER GUIDELINES	1
19	ZZUN9910	SURFACING WARNING LABEL KIT	1
20	ZZUN9930	PIPE SYSTEMS MAINTENANCE KIT W/ AEROSOL	1

Design Number: 350-1700A - Compliance and Technical Data

Reference Document: ASTM F1487

Ref. No.	Part No.	Qty.	Description	Unit ASTM Status	Total Weight (lbs)	Pre- Pos Consumer Recycled Conte (lbs)	CO2e	Users	Install Hours	Concrete (Yds3)	Active Play Events
1	ZZCH0028	3	3.5in OD x 136in STEEL POST W/ RIVETED CAP	Certified	130.53	3		0	3.00	0.38	0
2	ZZCH0237	6	3.5in OD x 168in SWAGED STEEL POST	Certified	309.66		409	0	3.00	0.75	0
3	ZZCH0617	3	TRIANGULAR COATED DECK ASSEMBLY	Certified	89.70		360	6	3.00	0.00	0
4	ZZCH0618	1	1/2 HEX COATED DECK ASSEMBLY	Certified	78.32		252	4	1.50	0.00	0
5	ZZCH2530	2	12in DECK TO DECK KICK PLATE	Certified	17.70		33	0	1.00	0.00	0
6	ZZUN2290	2	COATED DECK TO DECK CONNECTION KIT	Certified	0.58		8	0	1.00	0.00	0
7	ZZCH0678	1	NUVO- 48in TRANSFER STATION	Certified	299.54		563	3	3.50	0.12	0
8	ZZCH3206	1	SLITHER SLIDE 2.0 ENTRANCE & EXIT	Certified	85.37		424	2	2.00	0.03	1
9	ZZUN3209	2	SLITHER SLIDE 2.0 (LEFT SECTION)	Certified	39.18		267	0	0.50	0.00	0
10	ZZCH4290	1	POST MOUNTED STEERING WHEEL	Certified	7.83		44	1	0.25	0.00	1
11	ZZCH7037	1	48in TWINE CLIMBER	Certified	88.96		395	1	4.00	0.12	1
12	ZZCH7047	1	48in TWIST CLIMBER	Certified	96.81		598	1	1.50	0.03	1
13	ZZCH7056	1	36in CURVY CLIMBER	Certified	69.91		458	1	2.00	0.06	1
14	ZZCH5770	1	LEG LIFT	Certified	6.76		30	1	0.50	0.00	1
15	ZZCH5880	1	6ft HORIZONTAL SPIRAL LADDER	Certified	63.32		151	2	1.00	0.00	1
16	ZZCH5970	1	OVERHEAD EVENT ACCESS LADDER (36in DECK)	Certified	25.12		71	1	1.50	0.06	0
17	ZZCH9867	3	NUVO ROOF	Certified	254.79		1,781	0	6.00	0.00	0
18	ZZCHGUID	1	CHALLENGER GUIDELINES	N/A	0.00		1	0	0.25	0.00	0
19	ZZUN9910	1	SURFACING WARNING LABEL KIT	Certified	0.05		1	0	0.25	0.00	0
20	ZZUN9930	1	PIPE SYSTEMS MAINTENANCE KIT W/ AEROSOL	N/A			90				
				Totals:	1,664.13	261	518 6,111	23	35.75	1.54	7
					748.86 K	g 117 Kg	233 Kg 6	Metric T	ons	1.17	m3

Design Number: 350-1700A - Compliance and Technical Data

Reference Document: ASTM F1487

				Pre- Post-	•				
		Un	t Total	Consumer	CO2e				Active
Ref.		AST	M Weigh	t Recycled Conten	t Footprint		Install	Concrete	Play
No. Part No.	Qty. Description	Stat	us (lbs)	(lbs)	(kgs)	Users	Hours	(Yds3)	Events



ASTM F1487

The lay-out for this custom playscape, design number 350-1700A, has been configured to meet the requirements of the ASTM F1487 standard. In addition, each of the above components listed as "Certified" have been tested and are IPEMA certified. Components listed as "Not Applicable" do not fall within the scope of the ASTM F1487 standard and have not been tested. IPEMA certification can be verified on the IPEMA website, www.ipema.org. In the interest of playground safety, IPEMA provides a Third Party Certification Service which validates compliance.

2010 ADA Standards for Accessible Design

The lay-out was also designed to meet the 2010 Standards published 15-Sep-2010, by the Department of Justice when installed over a properly maintained surfacing material that is in compliance with ASTM F1951 "Accessibility of Surface Systems Under and Around Playground Equipment" as well as ASTM F1292, "Impact Attenuation of Surfacing Materials Within the Use Zone of Playground Equipment", appropriate for the fall height of the structure.

Installation Times

Installation times are based on one experienced installer. A crew of three experienced individuals can perform the installation within the given time, each member working 1/3 of the given hours. [Eg. Installation Time = 30 hours. For a crew of three, each member will work 10 hours on the installation for a total of 30 hours on the project.]

Carbon Footprint

The CO2e (carbon footprint given in Kilograms and Metric Tons) listed above is a measure of the environmental impact this play structure represents from harvesting raw materials to the time it leaves our shipping dock. Playworld Systems nurtures a total corporate culture that is focused on eliminating carbon producing processes and products, reducing our use of precious raw materials, reusing materials whenever possible and recycling materials at every opportunity. Playworld Systems elected to adopt the Publicly Available Specification; PAS 2050 as published by the British Standards Institute and sponsored by Defra and the Carbon Trust. The PAS 2050 has gained international acceptance as a specification that measures the greenhouse gas emissions in services and goods throughout their entire life cycle.

Pre-Consumer Recycle Content

A measurement, in pounds, that qualifies the amount of material that was captured as waste and diverted from landfill during an initial manufacturing process and is being redirected to a separate manufacturing process to become a different product. E.g. 100% of our Aluminum Tubing is made from captured waste material during the manufacturing process of extruded Aluminum products such as rods, flat bars and H-channels.

Post-Consumer Recycle Content

A measurement, in pounds, that qualifies the amount of material that was once another product that has completed its lifecycle and has been diverted from a landfill as a solid waste through recycling and is now being used in a Playworld Systems' product. E.g. **20% to 40% of the steel in our steel tubing and sheet steel have been diverted from landfills. Automobiles are scrapped and recyclable steel is purchased by the steel mill that produces our raw product. ** The amount of Post-Consumer recycled steel fluctuates daily based on the availability of the recycled steel.

