

Gold Leaf

Equipment Manufacturer



350-1709





Gold Leaf

Equipment Manufacturer



350-1709



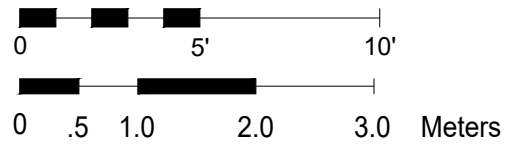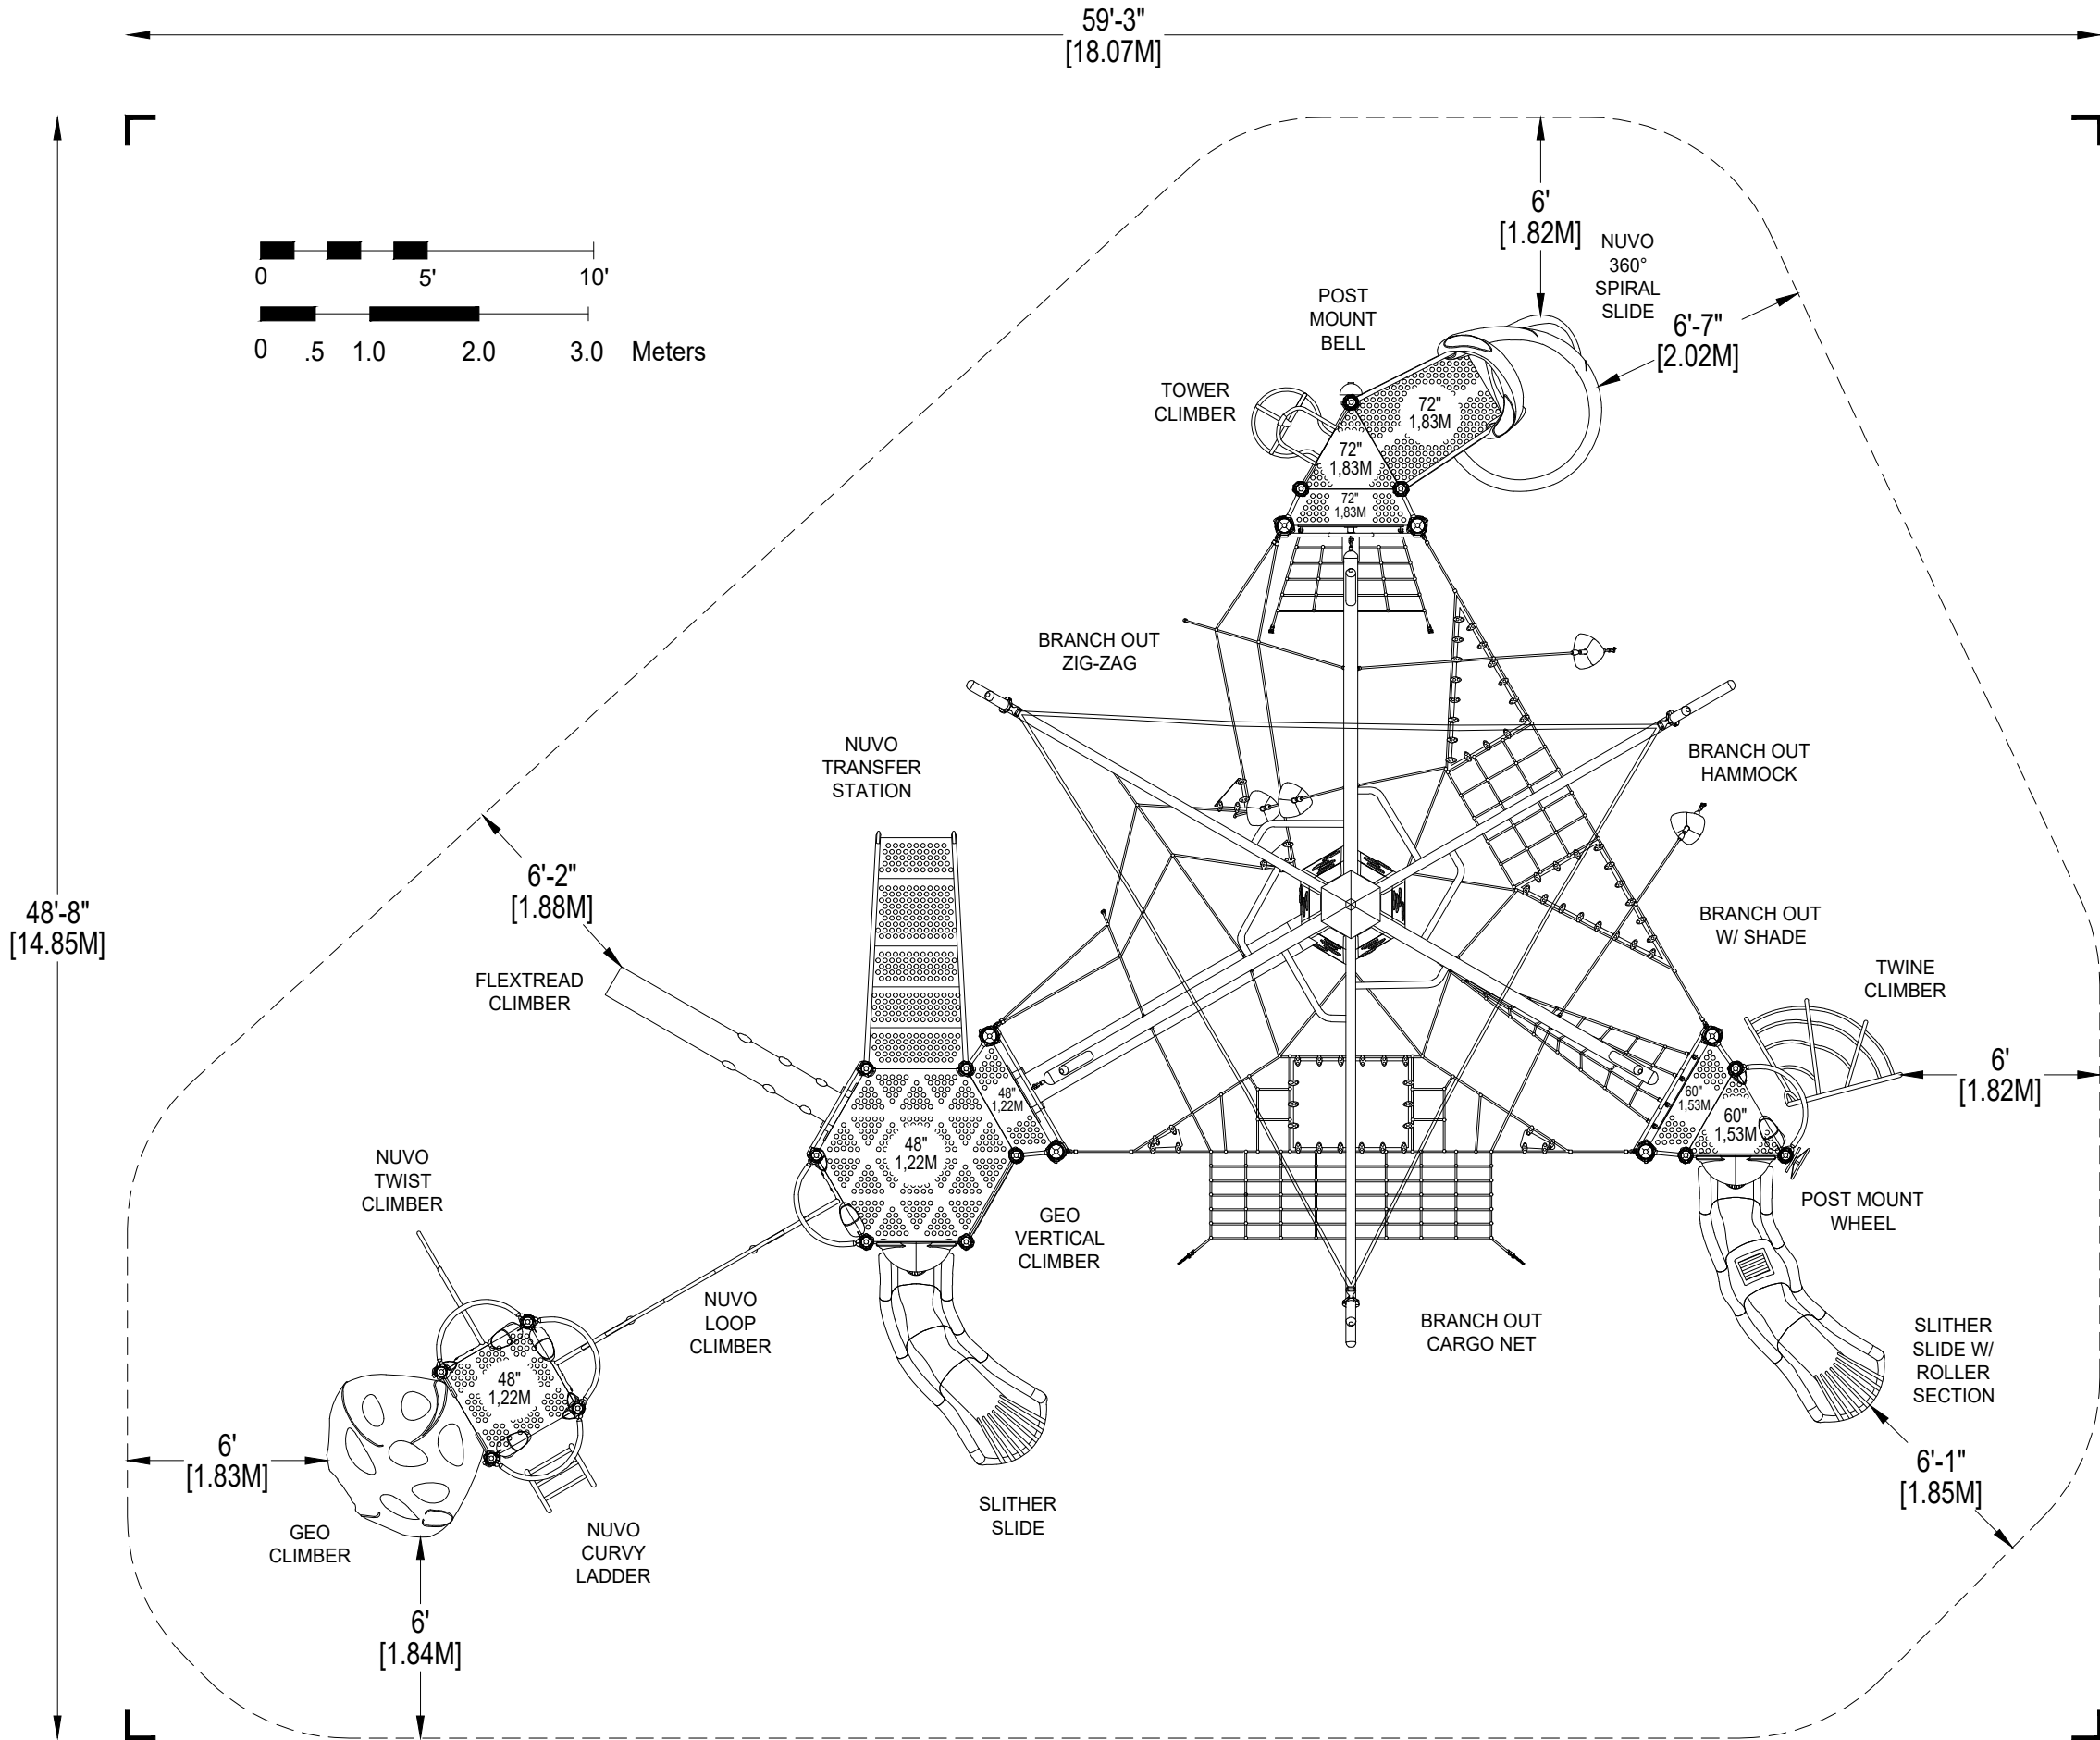

48'-8" [14.85M]

59'-3" [18.07M]

*PLAYGROUND SUPERVISION REQUIRED



PLAYWORLD SYSTEMS, INC.
 1000 Buffalo Road
 Lewisburg, PA
 17837-9795 USA

EQUIPMENT SIZE:
47'6" x 36'8" x 16'3"
 14,48M x 11,18M x 4,95M

USE ZONE:
59'3" x 48'8"
 18,07M x 14,85M

AREA: **2174 SqFt.** PERIMETER: **179 Ft.**
 201,97 SqM. 54,56M

FALL HEIGHT:
6 Ft.
 1,83M

USER CAPACITY: **73** AGE GROUP: **5-12**



ADA SCHEDULE	Total Elevated Play Activities: 12		
	Total Ground-Level Play Activities: 5		
	Accessible Elevated Activities	Accessible Ground-Level Activities	Accessible Ground-Level Play Types
Required	6	4	3
Provided	12	5	3

- ✓ ASTM F1487-17
- ✓ CPSC #325



PROJECT NO: 350-1709A	SCALE: 3/16"=1'-0"
DRAWN BY: M. MERTZ	Paper Size B
DATE: 20-DEC-17	

GOLD LEAF
 CATALOG PRE-DESIGN

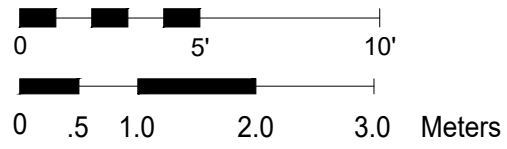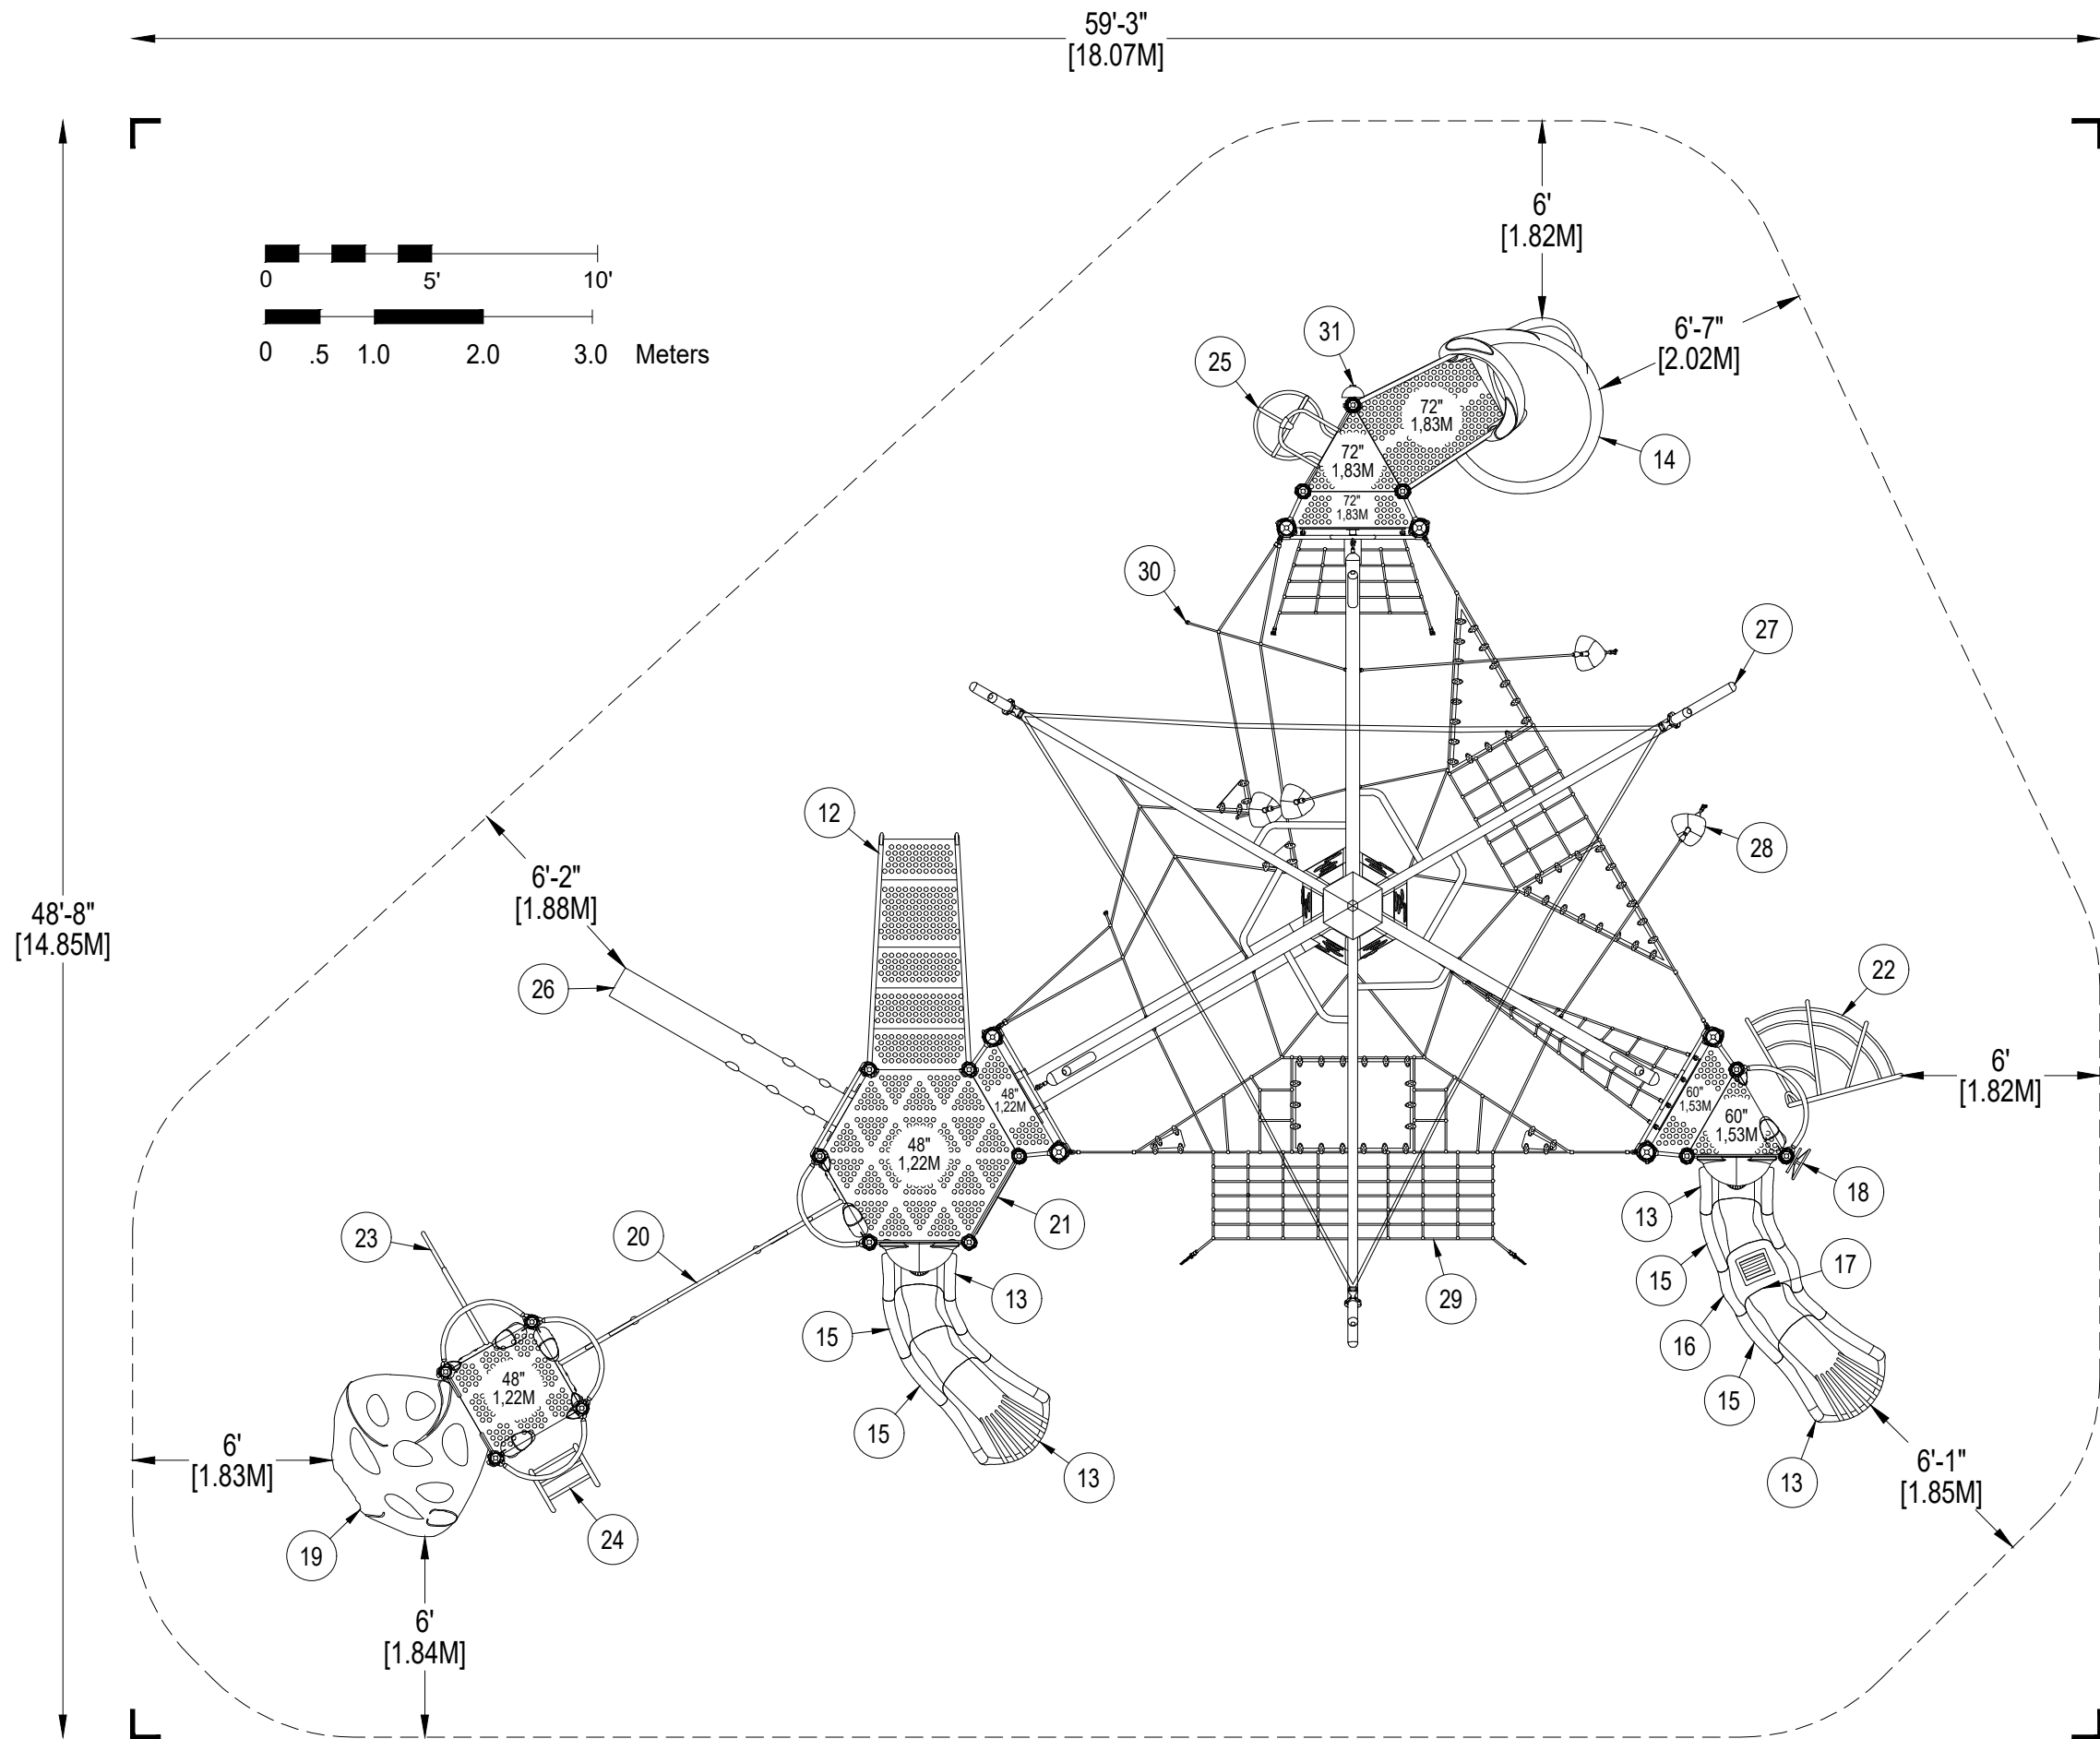

48'-8"
[14.85M]

59'-3"
[18.07M]

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PROJECT NO:
350-1709A

SCALE:
3/16"=1'-0"

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GOLD LEAF
CATALOG PRE-DESIGN


DETAIL 1

Support Post, Spiral Slide and RockBlocks Post Footing Detail



STONE OPTION

OR

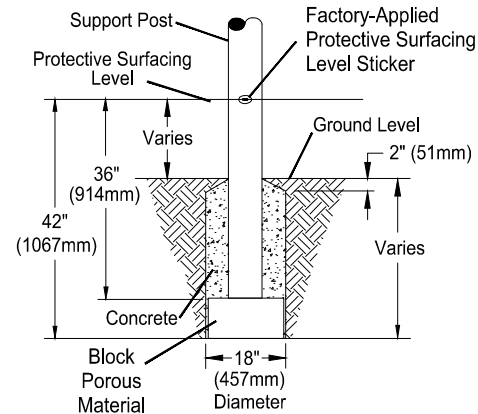

BLOCK OPTION

DETAIL 2

GroundZero, Cantilever and "T" Post Footing Detail



STONE OPTION


OR



BLOCK OPTION


DETAIL 3

Component Footing Detail

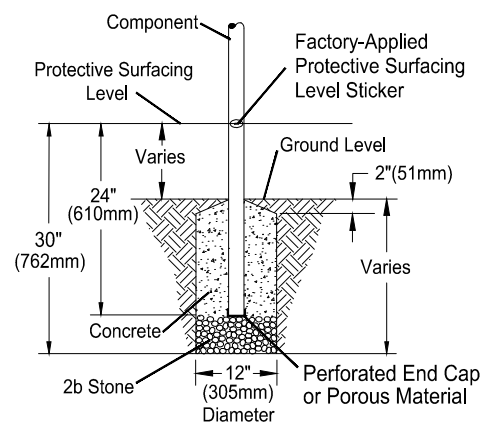

STONE OPTION

OR

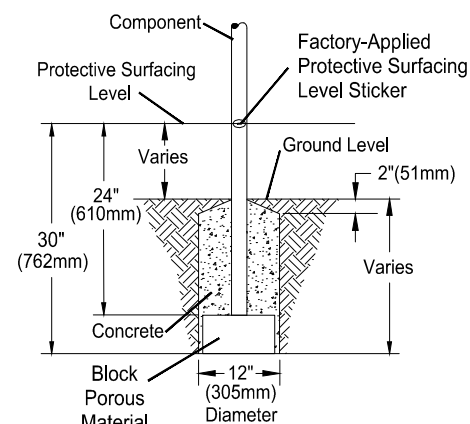

BLOCK OPTION

DETAIL 4

Surface Mount Detail





INSTALLATION NOTES:

- 1) Paved surfaces, such as asphalt and concrete, are not acceptable for use under your structure.
- 2) It is the consumer's responsibility to check with local utilities prior to excavating footings for any underground utility lines that may exist within the installation area.
- 3) It is the consumer's responsibility to check local soil conditions and drainage within the site area. Inquire with local contractors for appropriate recommendations.
- 4) If the structure is to be installed across uneven terrain, maintain the support post mark for protective surfacing level at the lowest grade. Adjust other footings accordingly.
- 5) The base of footings must be below frost lines.
- 6) Do not encase the bottom of support posts in concrete. Place all posts directly on packed stone.
- 7) Assemble the entire structure before pouring concrete unless specifically instructed to do so in the individual component installation instructions.
- 8) Read completely the installation instructions provided with your structure prior to beginning construction.

SITE NOTES:

- 1) The site plan provided must be checked against the actual site area to ensure that placement of your structure meets required clearances.
- 2) The dimensions labeled are for location of footing holes, not exact placement of equipment. Assemble, plumb, and level equipment before pouring concrete.
- 3) There must be a minimum distance of 6' (1830mm) between any obstacle, sidewalk, etc., and your structure.
- 4) Slides must have a use zone that extends out from the lower exit section of the slide a distance that is at least 6' (1830mm) or equal to the vertical distance from the highest point of the sliding surface to the top of the protective surfacing, whichever is greater. The slide use zone should not extend greater than 8' (2438mm) from the end of the lower exit section.
- 5) The complete area, including the space under and around the equipment, must be covered with an impact attenuating material. See the 1997 publication, "Handbook for Public Playground Safety", published by the U.S. Consumer Product Safety Commission, for guidelines and recommendations on the type and depth of surfacing material. For a copy of the "Handbook for Public Playground Safety", write to: **U.S. Consumer Product Safety Commission**, Office of Information and Public Affairs, Washington, D.C. 20207
- 6) Supervise children as they play.

FOOTING LEGEND

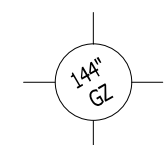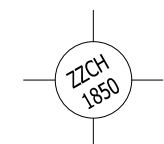

FOOTING DETAIL

SCALE:
NOT TO SCALE

DRAWN BY:
TECH SALES

Paper Size

DATE:
28-JUNE-13


B




PLAYWORLD SYSTEMS, INC.

1000 Buffalo Road
Lewisburg, PA
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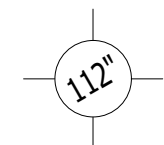
FOOTING LEGEND

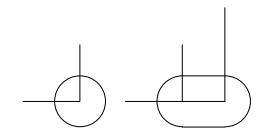


COMPONENT FOOTING (DETAIL 3)

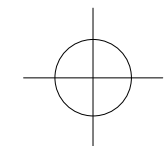


SPIRAL SLIDE CENTER POST FOOTING (DETAIL 1)




SUPPORT POST FOOTING (DETAIL 1 or 4)
(112" INDICATES POST LENGTH)

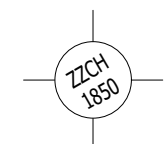

CANTILEVER, "T" POST, AND COMPONENT
POST FOOTING (DETAIL 2)
(ZZCH1850 INDICATES PART NUMBER)

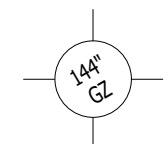

GROUND ZERO POST FOOTING (DETAIL 2)
(144" INDICATES POST LENGTH)

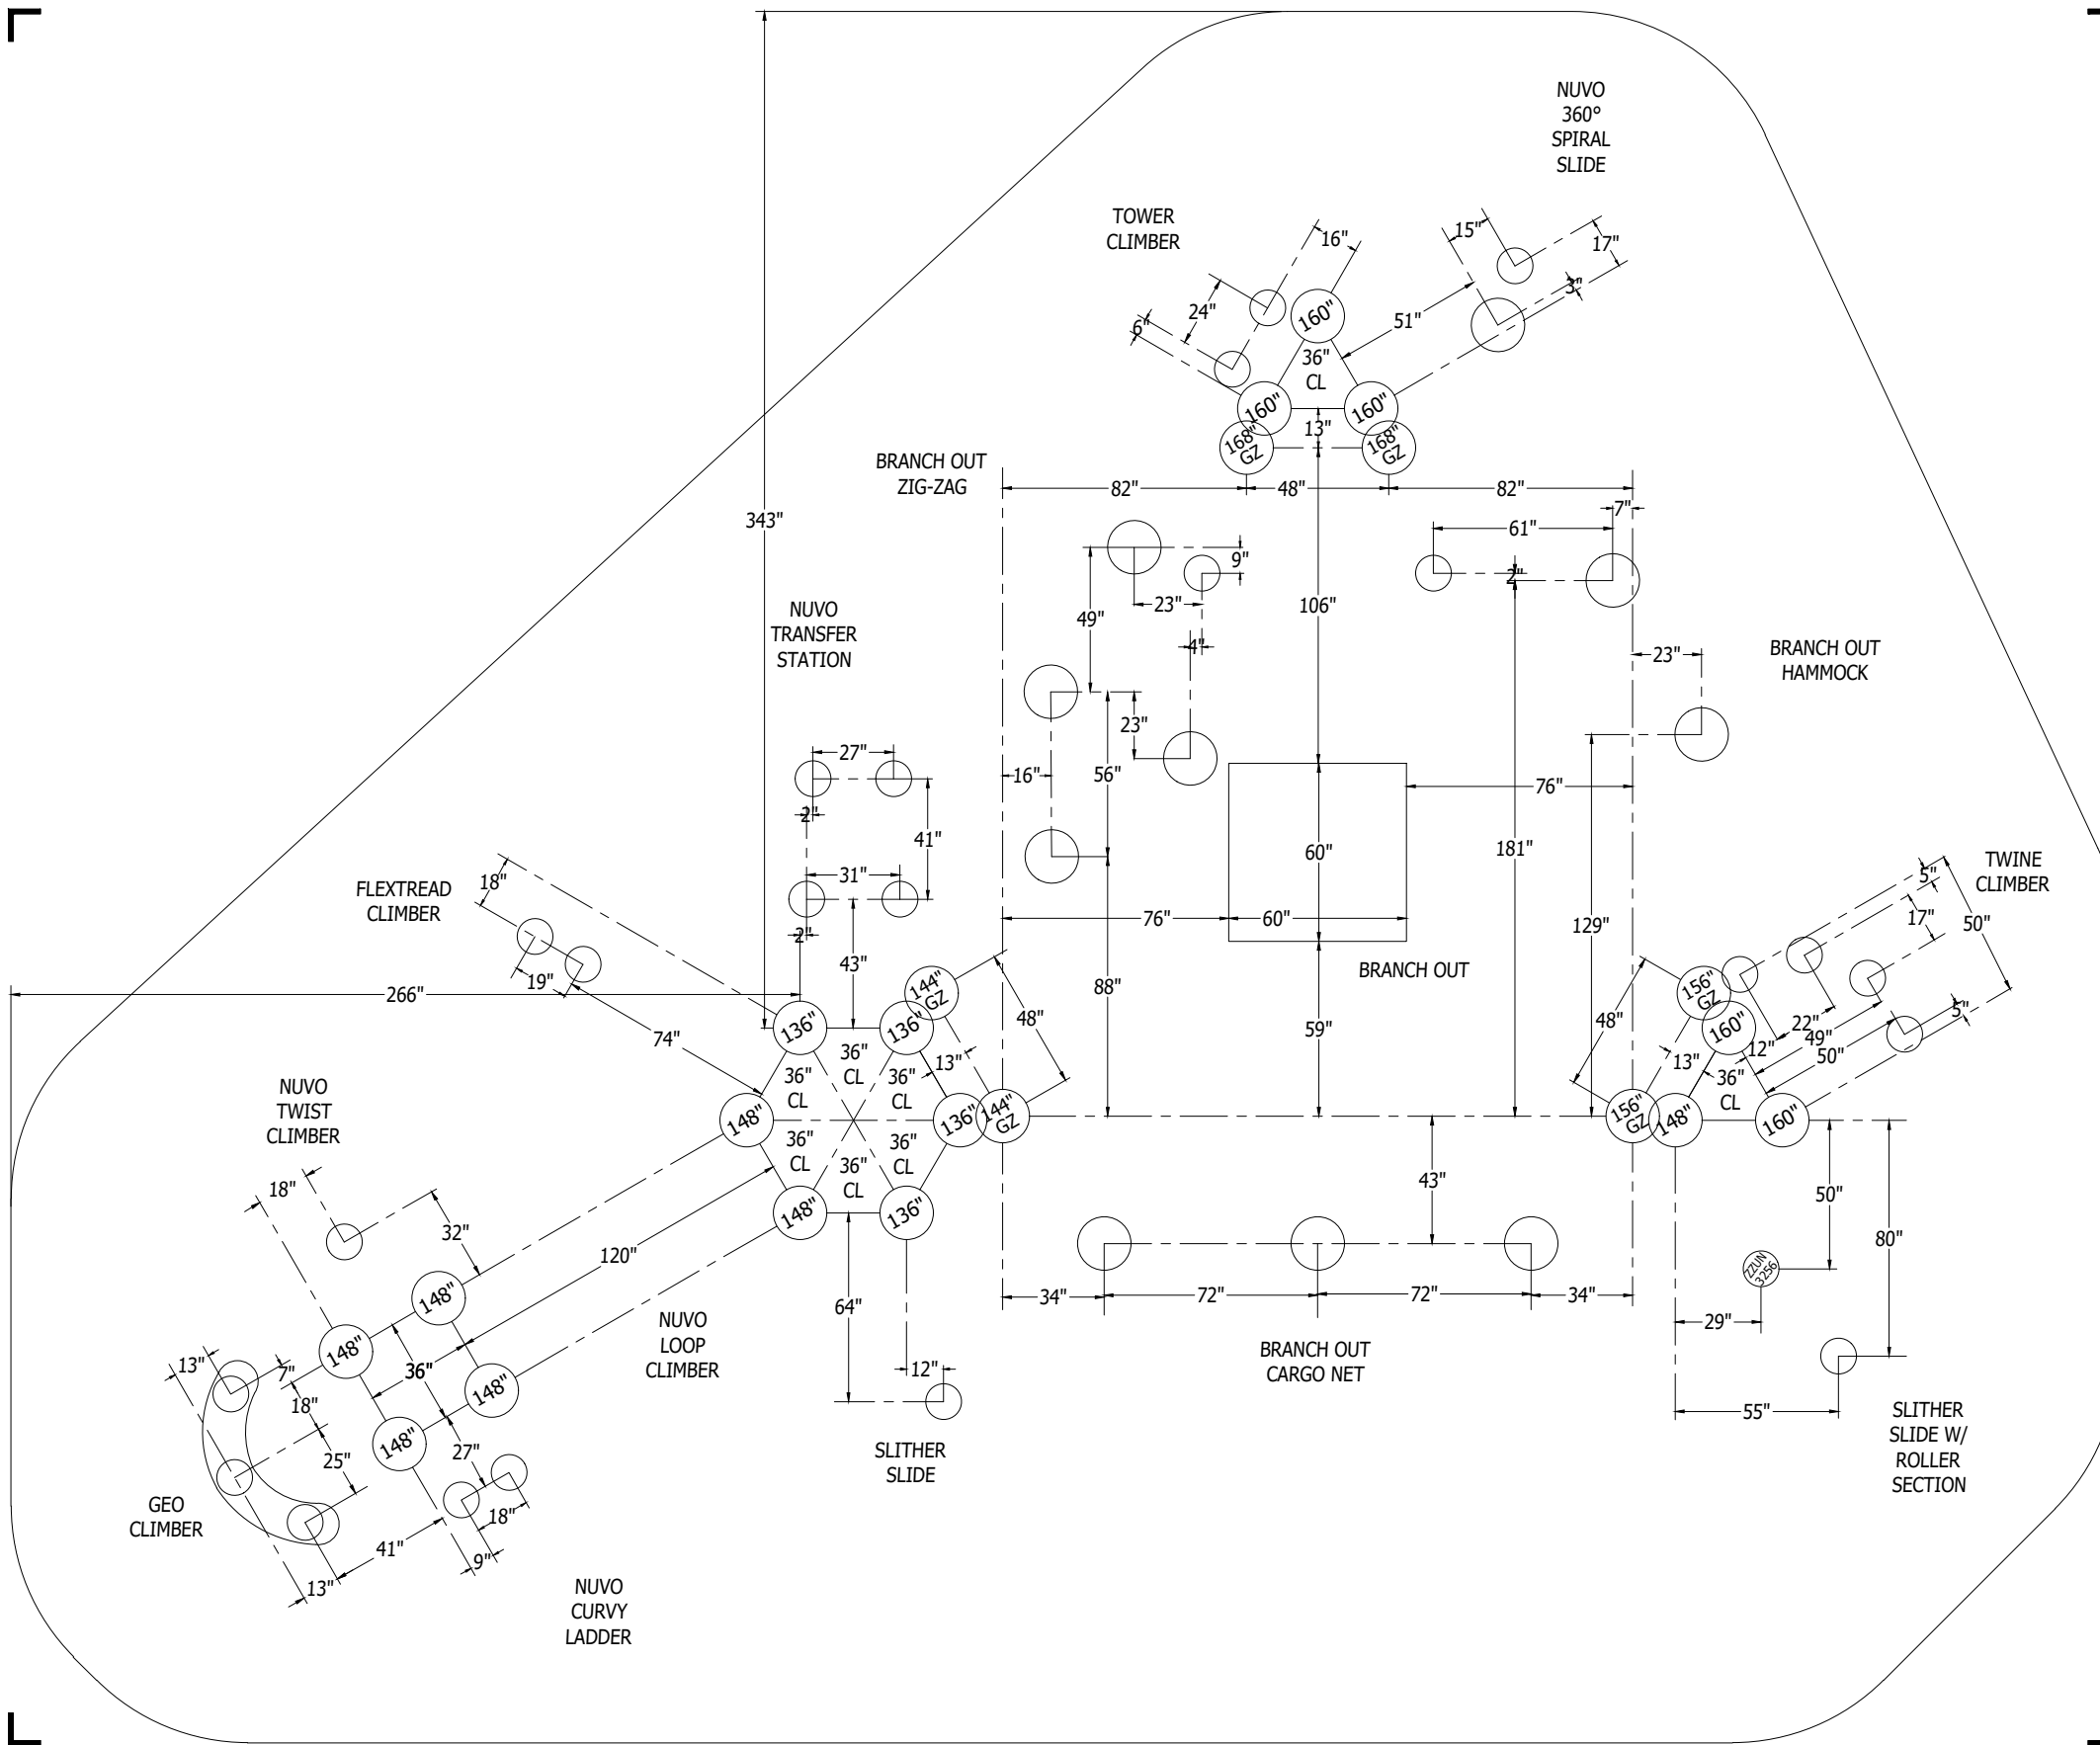

GOLD LEAF
CATALOG PRE-DESIGN

PROJECT NO:
350-1709A

SCALE:
3/16"=1'-0"

DRAWN BY:
M. MERTZ

Paper Size

DATE:
30-JUN-17

B

*PLAYGROUND SUPERVISION REQUIRED

Gold Leaf

Design Number: 350-1709A - Bill Of Material

Ref. No.	Part No.	Description	Quantity
Posts			
1	ZZCH0028	3.5in OD x 136in STEEL POST W/ RIVETED CAP	4
2	ZZCH0038	3.5in OD x 148in STEEL POST W/ RIVETED CAP	7
3	ZZCH0048	3.5in OD x 160in STEEL POST W/ RIVETED CAP	5
4	ZZPM0036GZ	5in OD X 144in STEEL POST (GROUND ZERO)	2
5	ZZPM0047GZ	5in x 156in GROUND ZERO POST - w/ CAP	2
6	ZZPM0056GZ	5in OD X 168in STEEL POST W/ CAP (GROUND ZERO)	2
Decks & Kick Plates			
7	ZZCH0616	SQUARE COATED DECK ASSEMBLY	1
8	ZZCH0617	TRIANGULAR COATED DECK ASSEMBLY	2
9	zzCH0619	FULL HEX COATED DECK ASSEMBLY	1
10	ZZUN2290	COATED DECK TO DECK CONNECTION KIT	3
11	ZZUN5898	CH/PM CONVERSION PLATFORM	3
ADA Items			
12	ZZCH0678	NUVO- 48in TRANSFER STATION	1
Slides			
13	ZZCH3206	SLITHER SLIDE 2.0 ENTRANCE & EXIT	2
14	ZZCH3537	SLIDE- NUVO 360 SPIRAL SLIDE	1
15	ZZUN3209	SLITHER SLIDE 2.0 (LEFT SECTION)	4
16	ZZUN3219	SLITHER SLIDE ROLLER SECTION	1
17	ZZUN3256	SLITHER SLIDE 2.0 SUPPORT LEG 2ft-6in	1
Activity Panels			
18	ZZCH4290	POST MOUNTED STEERING WHEEL	1
Climbers			
19	ZZCH6756	4ft GEO CLIMBER	1
20	ZZCH6957	NUVO LOOP CLIMBER	1
21	ZZCH6996	GEO VERTICAL CLIMBER (48in DK)	1
22	ZZCH7038	60in TWINE CLIMBER	1
23	ZZCH7047	48in TWIST CLIMBER	1
24	ZZCH7057	48in CURVY CLIMBER	1
25	ZZCH7168	6ft TOWER CLIMBER	1
26	ZZCH8266	48in SINGLE FLEX TREAD	1
27	ZZUN5890	BRANCH OUT TRUNK W/ FABRIC SHADE	1
28	ZZUN7896	BRANCH OUT HAMMOCK	1
29	ZZUN7897	BRANCH OUT CARGO NET	1
30	ZZUN7898	BRANCH OUT ZIG-ZAG	1
Audible Activities			
31	ZZCH4557	8in BELL (POST MOUNT)	1
Additional Tool & Maintenance Kits			
32	ZZCHGUID	CHALLENGER GUIDELINES	1
33	ZZUN9910	SURFACING WARNING LABEL KIT	1
34	ZZUN9930	PIPE SYSTEMS MAINTENANCE KIT W/ AEROSOL	1



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Design Number: 350-1709A - Compliance and Technical Data

Reference Document: ASTM F1487

Ref. No.	Part No.	Qty.	Description	Unit ASTM Status	Total Weight (lbs)	Pre-Consumer Recycled (lbs)	Post-Consumer Content (lbs)	CO2e Footprint (kgs)	Users	Install Hours	Concrete (Yds3)	Active Play Events
1	ZZCH0028	4	3.5in OD x 136in STEEL POST W/ RIVETED CAP	Certified	174.04			234	0	4.00	0.50	0
2	ZZCH0038	7	3.5in OD x 148in STEEL POST W/ RIVETED CAP	Certified	329.77			443	0	7.00	0.88	0
3	ZZCH0048	5	3.5in OD x 160in STEEL POST W/ RIVETED CAP	Certified	251.05			340	0	5.00	0.63	0
4	ZZPM0036GZ	2	5in OD X 144in STEEL POST (GROUND ZERO)	Certified	160.82			235	0	3.00	0.36	0
5	ZZPM0047GZ	2	5in x 156in GROUND ZERO POST - w/ CAP	Certified	180.86			253	0	2.00	0.36	0
6	ZZPM0056GZ	2	5in OD X 168in STEEL POST W/ CAP (GROUND ZERO)	Certified	194.02			271	0	2.00	0.36	0
7	ZZCH0616	1	SQUARE COATED DECK ASSEMBLY	Certified	54.86			174	3	1.00	0.00	0
8	ZZCH0617	2	TRIANGULAR COATED DECK ASSEMBLY	Certified	59.80			240	4	2.00	0.00	0
9	zzCH0619	1	FULL HEX COATED DECK ASSEMBLY	Certified	151.26			444	6	1.50	0.00	0
10	ZZUN2290	3	COATED DECK TO DECK CONNECTION KIT	Certified	0.87			11	0	1.50	0.00	0
11	ZZUN5898	3	CH/PM CONVERSION PLATFORM	Certified	178.35			674	3	6.00	0.00	0
12	ZZCH0678	1	NUVO- 48in TRANSFER STATION	Certified	299.54			563	3	3.50	0.12	0
13	ZZCH3206	2	SLITHER SLIDE 2.0 ENTRANCE & EXIT	Certified	170.74			848	4	4.00	0.06	2
14	ZZCH3537	1	SLIDE- NUVO 360 SPIRAL SLIDE	Certified	650.00			1,417	2	6.00	0.15	1
15	ZZUN3209	4	SLITHER SLIDE 2.0 (LEFT SECTION)	Certified	78.36			534	0	1.00	0.00	0
16	ZZUN3219	1	SLITHER SLIDE ROLLER SECTION	Certified	33.80			472	0	0.25	0.00	0
17	ZZUN3256	1	SLITHER SLIDE 2.0 SUPPORT LEG 2ft-6in	Certified	12.81			59	0	0.25	0.03	0
18	ZZCH4290	1	POST MOUNTED STEERING WHEEL	Certified	7.83			44	1	0.25	0.00	1
19	ZZCH6756	1	4ft GEO CLIMBER	Certified	114.52			528	2	2.00	0.09	1
20	ZZCH6957	1	NUVO LOOP CLIMBER	Certified	157.88			1,047	2	2.00	0.00	1
21	ZZCH6996	1	GEO VERTICAL CLIMBER (48in DK)	Certified	57.76			217	1	1.00	0.00	1
22	ZZCH7038	1	60in TWINE CLIMBER	Certified	90.17			401	1	4.00	0.12	1
23	ZZCH7047	1	48in TWIST CLIMBER	Certified	96.81			598	1	1.50	0.03	1
24	ZZCH7057	1	48in CURVY CLIMBER	Certified	73.10			464	1	2.00	0.06	1



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25	ZZCH7168	1	6ft TOWER CLIMBER	Certified	100.77			242	2	2.00	0.06	1
26	ZZCH8266	1	48in SINGLE FLEX TREAD	Certified	118.67			615	2	3.00	0.06	1
27	ZZUN5890	1	BRANCH OUT TRUNK W/ FABRIC SHADE	Certified	2,454.21			9,446	14	32.00	5.35	6
28	ZZUN7896	1	BRANCH OUT HAMMOCK	Certified	122.56			2,637	8	3.00	0.28	1
29	ZZUN7897	1	BRANCH OUT CARGO NET	Certified	143.08			2,502	6	3.50	0.42	1
30	ZZUN7898	1	BRANCH OUT ZIG-ZAG	Certified	112.97			1,415	6	4.00	0.56	1
31	ZZCH4557	1	8in BELL (POST MOUNT)	Certified	5.15			44	1	0.25	0.00	1
32	ZZCHGUID	1	CHALLENGER GUIDELINES	N/A	0.00			1	0	0.25	0.00	0
33	ZZUN9910	1	SURFACING WARNING LABEL KIT	Certified	0.05			1	0	0.25	0.00	0
34	ZZUN9930	1	PIPE SYSTEMS MAINTENANCE KIT W/ AEROSOL	N/A				90				
Totals:					6,636.48	1,024	2,127	27,501	73	111.00	10.47	22
					2,986.42 Kg	461 Kg	957 Kg	28 Metric Tons				7.96 m3



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ASTM F1487

The lay-out for this custom playscape, design number 350-1709A, has been configured to meet the requirements of the ASTM F1487 standard. In addition, each of the above components listed as "Certified" have been tested and are IPEMA certified. Components listed as "Not Applicable" do not fall within the scope of the ASTM F1487 standard and have not been tested. IPEMA certification can be verified on the IPEMA website, www.ipema.org. In the interest of playground safety, IPEMA provides a Third Party Certification Service which validates compliance.

2010 ADA Standards for Accessible Design

The lay-out was also designed to meet the 2010 Standards published 15-Sep-2010, by the Department of Justice when installed over a properly maintained surfacing material that is in compliance with ASTM F1951 "Accessibility of Surface Systems Under and Around Playground Equipment" as well as ASTM F1292, "Impact Attenuation of Surfacing Materials Within the Use Zone of Playground Equipment", appropriate for the fall height of the structure.

Installation Times

Installation times are based on one experienced installer. A crew of three experienced individuals can perform the installation within the given time, each member working 1/3 of the given hours. [Eg. Installation Time = 30 hours. For a crew of three, each member will work 10 hours on the installation for a total of 30 hours on the project.]

Carbon Footprint

The CO2e (carbon footprint given in Kilograms and Metric Tons) listed above is a measure of the environmental impact this play structure represents from harvesting raw materials to the time it leaves our shipping dock. Playworld Systems nurtures a total corporate culture that is focused on eliminating carbon producing processes and products, reducing our use of precious raw materials, reusing materials whenever possible and recycling materials at every opportunity. Playworld Systems elected to adopt the Publicly Available Specification; PAS 2050 as published by the British Standards Institute and sponsored by Defra and the Carbon Trust. The PAS 2050 has gained international acceptance as a specification that measures the greenhouse gas emissions in services and goods throughout their entire life cycle.

Pre-Consumer Recycle Content

A measurement, in pounds, that qualifies the amount of material that was captured as waste and diverted from landfill during an initial manufacturing process and is being redirected to a separate manufacturing process to become a different product. E.g. 100% of our Aluminum Tubing is made from captured waste material during the manufacturing process of extruded Aluminum products such as rods, flat bars and H-channels.

Post-Consumer Recycle Content

A measurement, in pounds, that qualifies the amount of material that was once another product that has completed its lifecycle and has been diverted from a landfill as a solid waste through recycling and is now being used in a Playworld Systems' product. E.g. **20% to 40% of the steel in our steel tubing and sheet steel have been diverted from landfills. Automobiles are scrapped and recyclable steel is purchased by the steel mill that produces our raw product.

** The amount of Post-Consumer recycled steel fluctuates daily based on the availability of the recycled steel.

