Equipment Manufacturer



500-1806




Equipment Manufacturer



500-1806



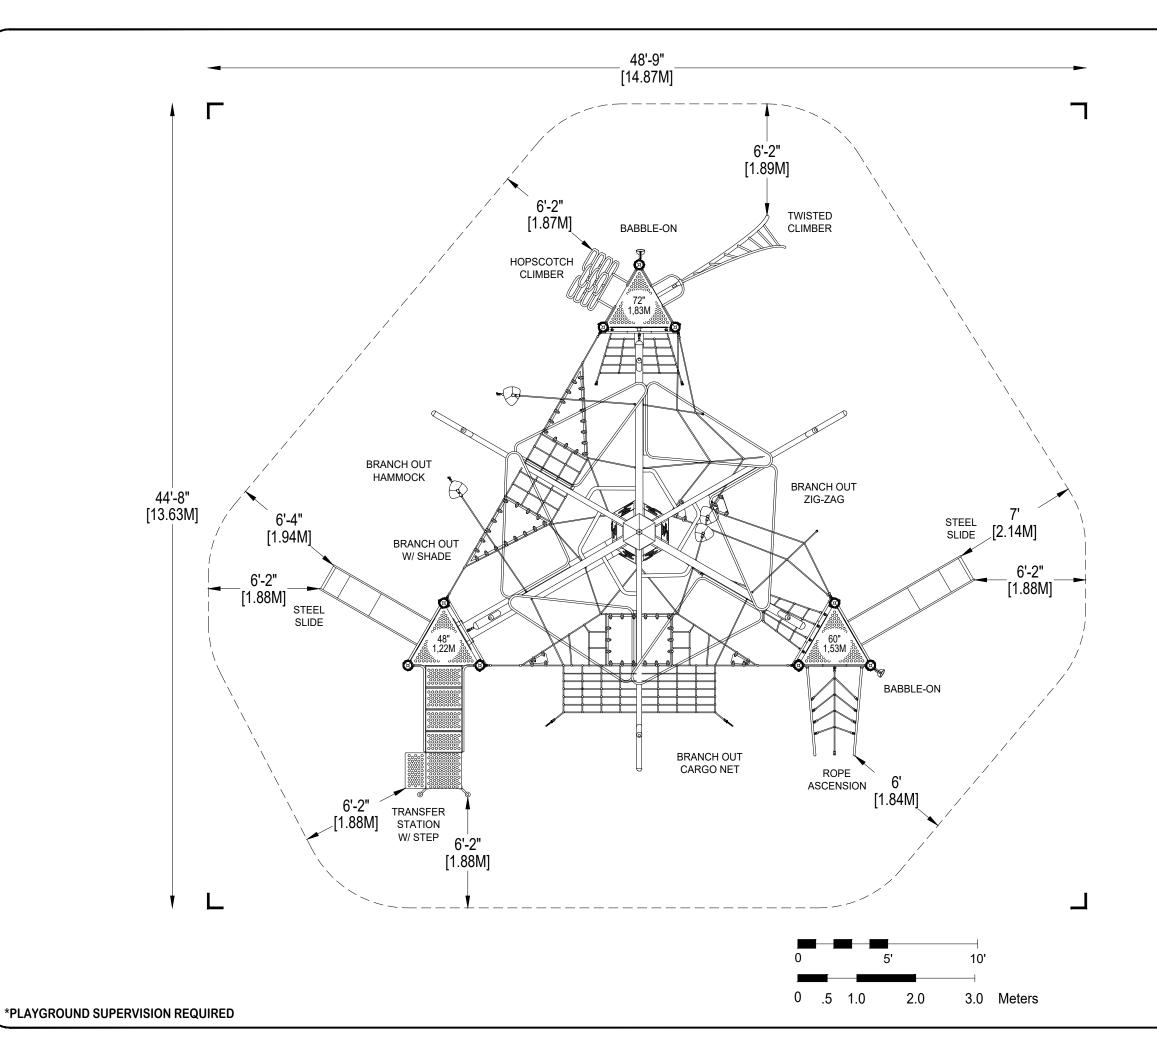



PLAYWORLD SYSTEMS, INC.

1000 Buffalo Road Lewisburg, PA 17837-9795 USA

EQUIPMENT SIZE:

36'5" x 32'4" x 16'5"

11,1M x 9,85M x 5,0M

USE ZONE:

48'9" x 44'8"

14,87M x 13,63M

AREA: **1,624 SqFt.**

PERIMETER: 148 Ft.

150,87 SqM.

45,11M

FALL HEIGHT:

7 Ft.

2,13M

USER CAPACITY:

51

AGE GROUP: 5-12

	E	Total Elevate	ed Play Activities	6			
	Ē	Total Ground-Level Play Activities: 4					
	ADA SCHEDULE	Accessible Elevated Activities	Accessible Ground-Level Activities	Accessible Ground-Level Play Types			
Required		3	2	2			
Provi	ided	6	4	2			

✓ ASTM F1487-11

✓ CPSC #325

31-OCT-17



PROJECT NO:	SCALE:
500-1806	3/16"=1'-0"
DRAWN BY:	Paper Size
M. MERTZ	1 aper oize
DATE:	l B
24 OCT 47	

*PLAYGROUND SUPERVISION REQUIRED



PLAYWORLD SYSTEMS, INC.

1000 Buffalo Road Lewisburg, PA 17837-9795 USA

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JONOC

URBAN

CATALOG PRE-DESIGN

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45,11M

FALL HEIGHT:

7 Ft.

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AGE GROUP:

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	Required		3	2	2			
Provided		ded	6	4	2			

✓ ASTM F1487-11

✓ CPSC #325

3.0 Meters




PROJECT NO: 500-1806	SCALE: 3/16"=1'-0"
DRAWN BY: M. MERTZ	Paper Size
DATE:	l K

31-OCT-17


DETAIL 1

Support Post, Spiral Slide and RockBlocks Post Footing Detail

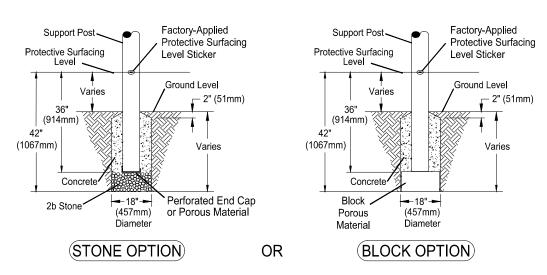

DETAIL 2

GroundZerO. Cantilever and "T" Post Footing Detail

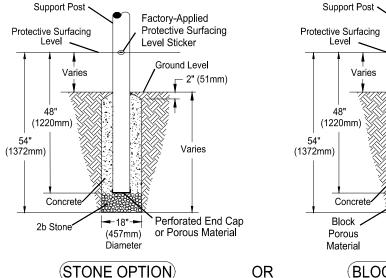


(BLOCK OPTION)

(457mm)


Diameter

DETAIL 3 Component Footing Detail

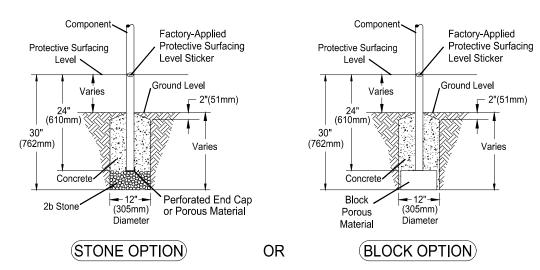

DETAIL 4

Surface Mount Detail

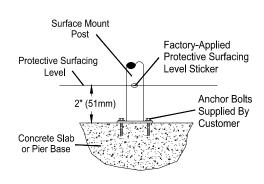

INSTALLATION NOTES:

1) Paved surfaces, such as asphalt and concrete, are not acceptable for use under your structure.

Factory-Applied

Level Sticker

Protective Surfacing

Ground Level

Varies

2" (51mm)

- 2) It is the consumer's responsibility to check with local utilities prior to excavating footings for any underground utility lines that may exist within the installation area.
- 3) It is the consumer's responsibility to check local soil conditions and drainage within the site area. Inquire with local contractors for appropriate recommendations.
- 4) If the structure is to be installed across uneven terrain maintain the support post mark for protective surfacing level at the lowest grade. Adjust other footings accordingly.
- 5) The base of footings must be below frost lines.
- 6) Do not encase the bottom of support posts in concrete. Place all posts directly on packed stone.
- 7) Assemble the entire structure before pouring concrete unless specifically instructed to do so in the individual component installation instructions.
- 8) Read completely the installation instructions provided with your structure prior to beginning construction.

SITE NOTES:

- 1) The site plan provided must be checked against the actual site area to ensure that placement of your structure meets required clearances.
- 2) The dimensions labeled are for location of footing holes, not exact placement of equipment. Assemble, plumb, and level equipment before pouring concrete.
- 3) There must be a minimum distance of 6' (1830mm) between any obstacle, sidewalk, etc., and your structure.
- 4) Slides must have a use zone that extends out from the lower exit section of the slide a distance that is at least 6' (1830mm) or equal to the vertical distance from the highest point of the sliding surface to the top of the protective surfacing, whichever is greater. The slide use zone should not extend greater than 8' (2438mm) from the end of the lower exit section
- 5) The complete area, including the space under and around the equipment, must be covered with an impact attenuating material. See the 1997 publication, "Handbook for Public Playground Safety" published by the U.S. Consumer Product Safety Commission, for guidelines and recommendations on the type and depth of surfacing material. For a copy of the "Handbook for Public Playground Safety" write to: U.S. Consumer Product Safety Commission Office of Information and Public Affairs

Washington, D.C. 20207


6) Supervise children as they play

⇒ PLAYWORLD*

PLAYWORLD SYSTEMS, INC.

1000 Buffalo Road Lewisburg, PA 17837-9795 USA

FOOTING LEGEND

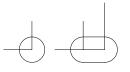

COMPONENT FOOTING (DETAIL 3)



CHALLENGERS

PLAYMAKERS

F0

SPIRAL SLIDE CENTER POST FOOTING (DETAIL1)



SUPPORT POST FOOTING (DETAIL 1 or 4) (112" INDICATES POST LENGTH)



CANTILEVER, "T" POST, AND COMPONENT POST FOOTING (DETAIL 2) (ZZCH1850 INDICATES PART NUMBER)



GROUND ZERO POST FOOTING (DETAIL 2) (144" INDICATES POST LENGTH)

FOOTING DETAIL


SCALE: NOT TO SCALE

DRAWN BY: **TECH SALES**

28-JUNE-13

Paper Size

В

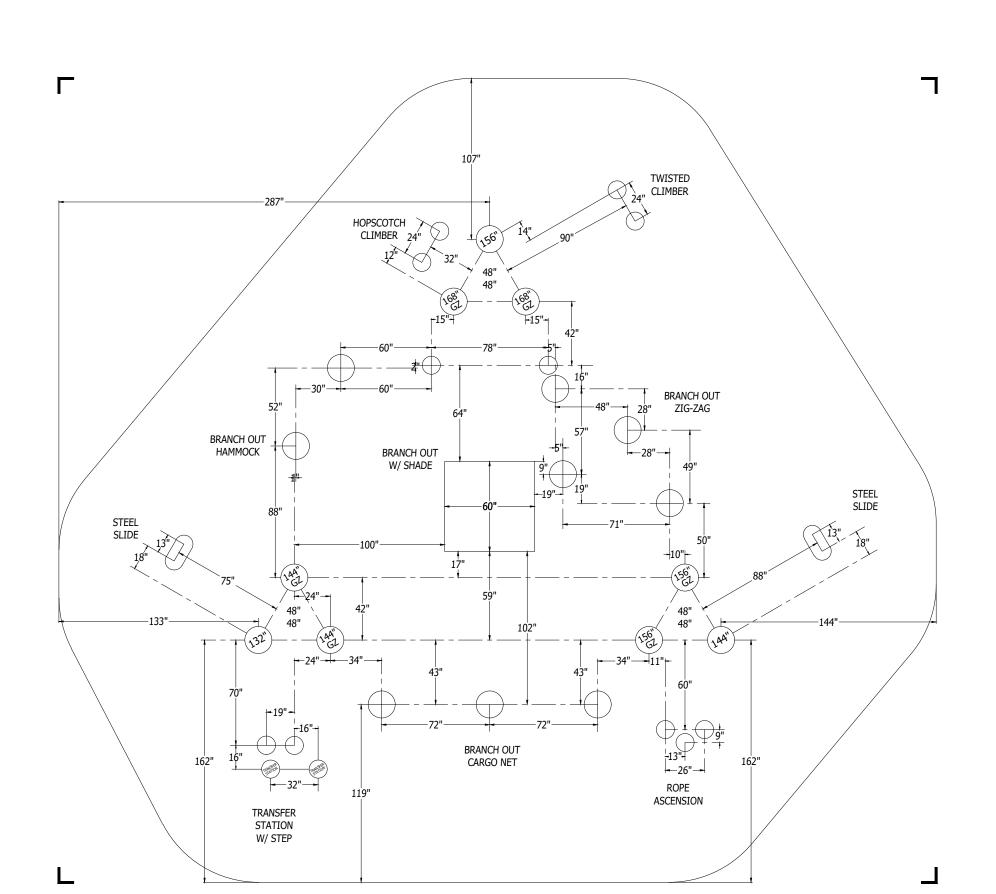



PLAYWORLD SYSTEMS, INC.

1000 Buffalo Road Lewisburg, PA 17837-9795 USA

FOOTING LEGEND



COMPONENT FOOTING (DETAIL 3)



SPIRAL SLIDE CENTER POST FOOTING (DETAIL1)



SUPPORT POST FOOTING (DETAIL 1 or 4) (112" INDICATES POST LENGTH)



CANTILEVER, "T" POST, AND COMPONENT POST FOOTING (DETAIL 2)
(ZZCH1850 INDICATES PART NUMBER)



GROUND ZERO POST FOOTING (DETAIL 2) (144" INDICATES POST LENGTH)

PROJECT NO:	SCALE:
500-1806	3/16"=1'-0"
DRAWN BY:	Danas Cina

Paper Size M. MERTZ B

DATE:

31-OCT-17

*PLAYGROUND SUPERVISION REQUIRED

Design Number: 500-1806 - Bill Of Material

Ref.

No.	Part No.	Description	Quantity
	Posts		_
1	ZZPM0026	5in OD X 132in STEEL POST W/ RIVETED CAP	1
2	ZZPM0036	5in OD X 144in STEEL POST W/ RIVETED CAP	1
3	ZZPM0036GZ	5in OD X 144in STEEL POST (GROUND ZERO)	2
4	ZZPM0046	5in OD X 156in STEEL POST W/ RIVETED CAP	1
5	ZZPM0047GZ	5in x 156in GROUND ZERO POST - w/ CAP	2
6	ZZPM0056GZ	5in OD X 168in STEEL POST W/ CAP (GROUND ZERO)	2
	Decks & Kicl	k Plates	
7	ZZPM0617	TRIANGULAR COATED DECK ASSEMBLY	3
	ADA Items		
8	ZZPM2027	TRANSFER STATION (48in DECK)	1
9	ZZUN2019	APPROACH STEP FOR TRANSFER STATION	1
	Slides		
10	ZZPM2908	STAINLESS STEEL SLIDE- 60in DECK	1
11	ZZPM2909	STAINLESS STEEL SLIDE- 48in DECK	1
	Climbers		
12	ZZPM7160	6ft TWISTED CLIMBER	1
13	ZZPM7219	60in ROPE ASCENSION	1
14	ZZPM8280	HOPSCOTCH CLIMBER (72in DECK)	1
15	ZZUN5896	BRANCH OUT TRUNK W/ PERFORATED STEEL CANOPY	1
16	ZZUN7896	BRANCH OUT HAMMOCK	1
17	ZZUN7897	BRANCH OUT CARGO NET	1
18	ZZUN7898	BRANCH OUT ZIG-ZAG	1
	Audible Activ	vities	
19	ZZPM4467	GROUND TO GROUND BABBLE-ON	1
	Additional T	ool & Maintenance Kits	
20	ZZPMGUID	PLAYMAKER GUIDELINES	1
21	ZZUN9910	SURFACING WARNING LABEL KIT	1
22	ZZUN9930	PIPE SYSTEMS MAINTENANCE KIT W/ AEROSOL	1

Design Number: 500-1806 - Compliance and Technical Data

Reference Document: ASTM F1487

Ref. No.	Part No.	Qty.	Description	Unit ASTM Status	Total Weight (lbs)	Pre- Post- Consumer Recycled Content (lbs)	CO2e Footprint (kgs)	Users	Install Hours	Concrete (Yds3)	Active Play Events
1	ZZPM0026	1	5in OD X 132in STEEL POST W/ RIVETED CAP	Certified	74.21		108	0	1.00	0.12	0
2	ZZPM0036	1	5in OD X 144in STEEL POST W/ RIVETED CAP	Certified	80.91		117	0	1.00	0.13	0
3	ZZPM0036GZ	2	5in OD X 144in STEEL POST (GROUND ZERO)	Certified	160.82		235	0	3.00	0.36	0
4	ZZPM0046	1	5in OD X 156in STEEL POST W/ RIVETED CAP	Certified	87.71		126	0	1.00	0.13	0
5	ZZPM0047GZ	2	5in x 156in GROUND ZERO POST - w/ CAP	Certified	180.86		253	0	2.00	0.36	0
6	ZZPM0056GZ	2	5in OD X 168in STEEL POST W/ CAP (GROUND ZERO)	Certified	194.02		271	0	2.00	0.36	0
7	ZZPM0617	3	TRIANGULAR COATED DECK ASSEMBLY	Certified	139.20		508	6	3.00	0.00	0
8	ZZPM2027	1	TRANSFER STATION (48in DECK)	Certified	287.44		567	3	2.00	0.09	0
9	ZZUN2019	1	APPROACH STEP FOR TRANSFER STATION	Certified	35.83		72	1	1.00	0.04	0
10	ZZPM2908	1	STAINLESS STEEL SLIDE- 60in DECK	N/A	165.10		322	0	4.00	0.06	0
11	ZZPM2909	1	STAINLESS STEEL SLIDE- 48in DECK	Certified	145.30		292	2	4.00	0.06	1
12	ZZPM7160	1	6ft TWISTED CLIMBER	Certified	128.99		256	2	2.00	0.60	1
13	ZZPM7219	1	60in ROPE ASCENSION	Certified	104.29		526	1	3.00	0.18	1
14	ZZPM8280	1	HOPSCOTCH CLIMBER (72in DECK)	Certified	101.06		186	2	2.00	0.06	1
15	ZZUN5896	1	BRANCH OUT TRUNK W/ PERFORATED STEEL CANOPY	Certified	2,929.42		8,652	14	32.00	5.35	6
16	ZZUN7896	1	BRANCH OUT HAMMOCK	Certified	122.56		2,637	8	3.00	0.28	1
17	ZZUN7897	1	BRANCH OUT CARGO NET	Certified	143.08		2,502	6	3.50	0.42	1
18	ZZUN7898	1	BRANCH OUT ZIG-ZAG	Certified	112.97		1,415	6	4.00	0.56	1
19	ZZPM4467	1	GROUND TO GROUND BABBLE-ON	Certified	45.47		248	2	1.50	0.00	1
20	ZZPMGUID	1	PLAYMAKER GUIDELINES	N/A	0.00		1	0	0.25	0.00	0
21	ZZUN9910	1	SURFACING WARNING LABEL KIT	Certified	0.05		1	0	0.25	0.00	0
22	ZZUN9930	1	PIPE SYSTEMS MAINTENANCE KIT W/ AEROSOL	N/A			90				

Design Number: 500-1806 - Compliance and Technical Data

Reference Document: ASTM F1487

Ref. No. Part No.	Qty. Description	Unit Total ASTM Weight Status (lbs)		Pre- Post- Consumer Recycled Content (lbs)		CO2e Footprint (kgs)	Users	Install Hours	Concrete (Yds3)	Active Play Events
		Totals:	5,239.29	919	1,941	19,384	53	75.50	9.16	14
			2.357.68 Kd	a 414 Ka	873	Ka 19	Metric To	ons	6.96	m3

Design Number: 500-1806 - Compliance and Technical Data

Reference Document: ASTM F1487

				Pre- Post-					
		Unit	Total	Consumer	CO2e				Active
Ref.		ASTM	Weight	Recycled Content	Footprint		Install	Concrete	Play
No. Part No.	Qty. Description	Status	(lbs)	(lbs)	(kgs)	Users	Hours	(Yds3)	Events



ASTM F1487

The lay-out for this custom playscape, design number 500-1806, has been configured to meet the requirements of the ASTM F1487 standard. In addition, each of the above components listed as "Certified" have been tested and are IPEMA certified. Components listed as "Not Applicable" do not fall within the scope of the ASTM F1487 standard and have not been tested. IPEMA certification can be verified on the IPEMA website, www.ipema.org. In the interest of playground safety, IPEMA provides a Third Party Certification Service which validates compliance.

2010 ADA Standards for Accessible Design

The lay-out was also designed to meet the 2010 Standards published 15-Sep-2010, by the Department of Justice when installed over a properly maintained surfacing material that is in compliance with ASTM F1951 "Accessibility of Surface Systems Under and Around Playground Equipment" as well as ASTM F1292, "Impact Attenuation of Surfacing Materials Within the Use Zone of Playground Equipment", appropriate for the fall height of the structure.

Installation Times

Installation times are based on one experienced installer. A crew of three experienced individuals can perform the installation within the given time, each member working 1/3 of the given hours. [Eg. Installation Time = 30 hours. For a crew of three, each member will work 10 hours on the installation for a total of 30 hours on the project.]

Carbon Footprint

The CO2e (carbon footprint given in Kilograms and Metric Tons) listed above is a measure of the environmental impact this play structure represents from harvesting raw materials to the time it leaves our shipping dock. Playworld Systems nurtures a total corporate culture that is focused on eliminating carbon producing processes and products, reducing our use of precious raw materials, reusing materials whenever possible and recycling materials at every opportunity. Playworld Systems elected to adopt the Publicly Available Specification; PAS 2050 as published by the British Standards Institute and sponsored by Defra and the Carbon Trust. The PAS 2050 has gained international acceptance as a specification that measures the greenhouse gas emissions in services and goods throughout their entire life cycle.

Pre-Consumer Recycle Content

A measurement, in pounds, that qualifies the amount of material that was captured as waste and diverted from landfill during an initial manufacturing process and is being redirected to a separate manufacturing process to become a different product. E.g. 100% of our Aluminum Tubing is made from captured waste material during the manufacturing process of extruded Aluminum products such as rods, flat bars and H-channels.

Post-Consumer Recycle Content

A measurement, in pounds, that qualifies the amount of material that was once another product that has completed its lifecycle and has been diverted from a landfill as a solid waste through recycling and is now being used in a Playworld Systems' product. E.g. **20% to 40% of the steel in our steel tubing and sheet steel have been diverted from landfills. Automobiles are scrapped and recyclable steel is purchased by the steel mill that produces our raw product. ** The amount of Post-Consumer recycled steel fluctuates daily based on the availability of the recycled steel.

